


Welcome to the Planning Committee

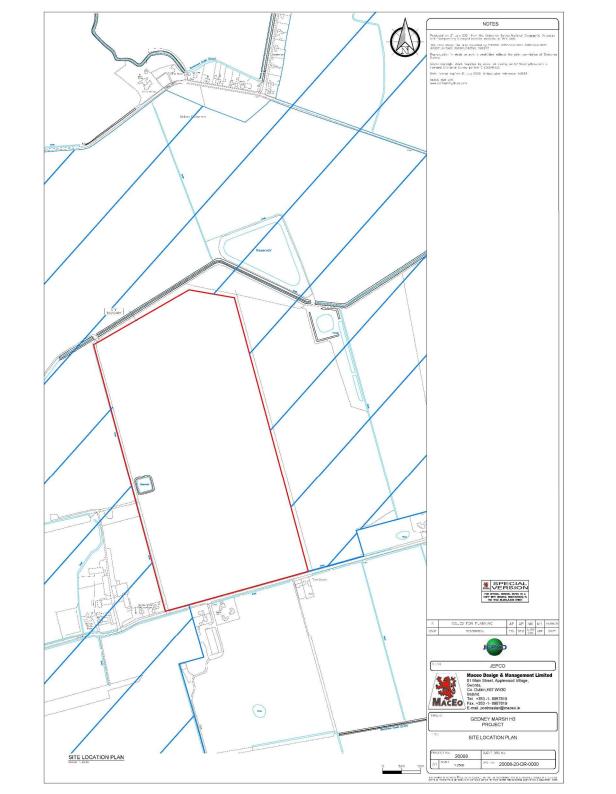

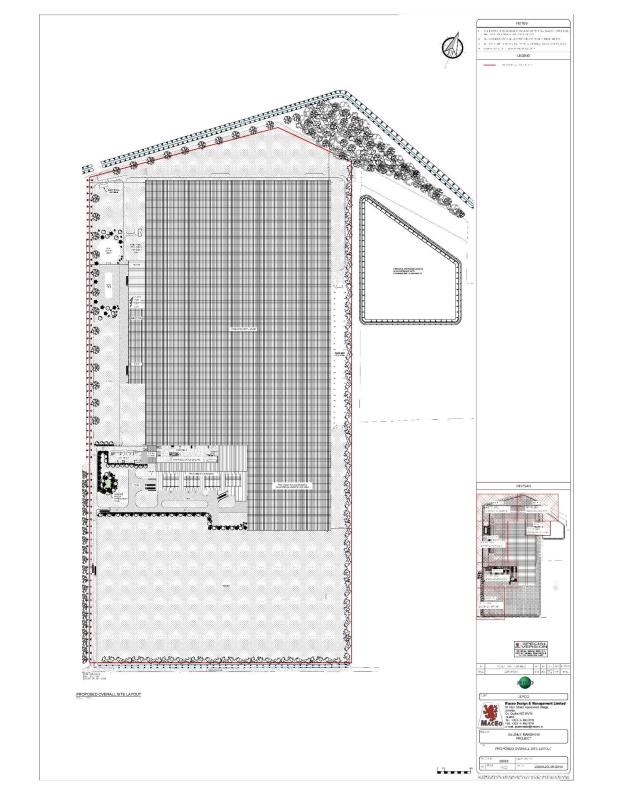


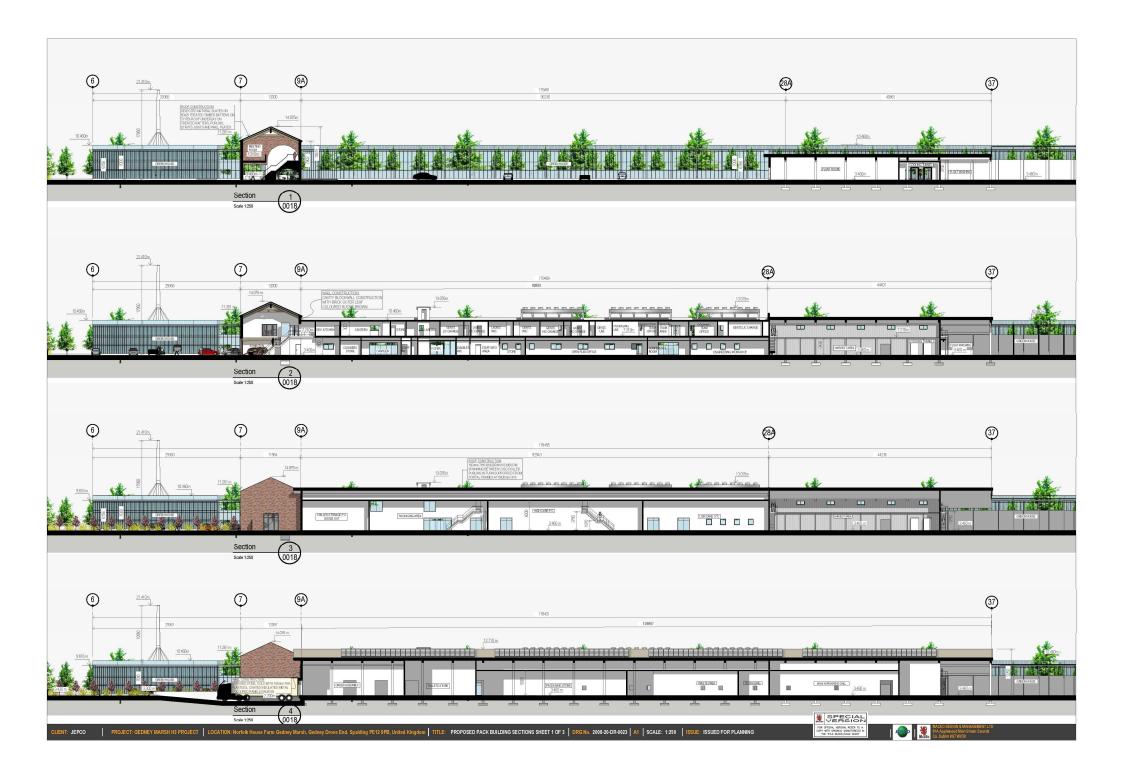









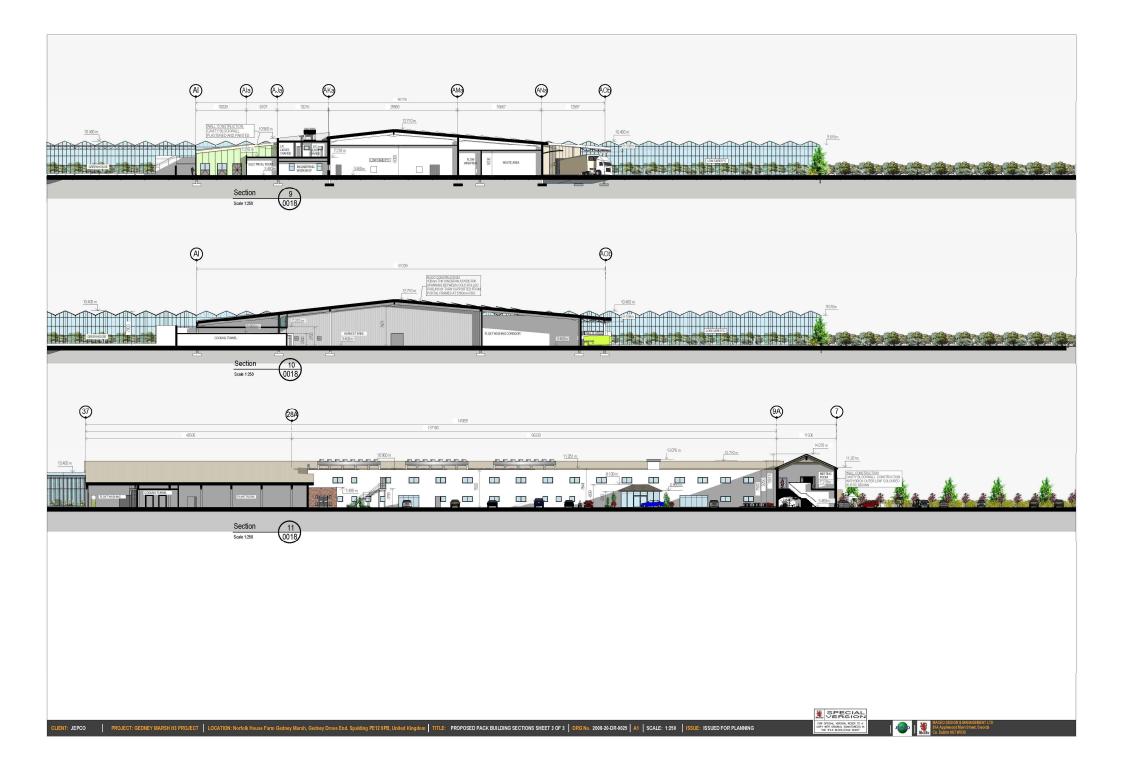

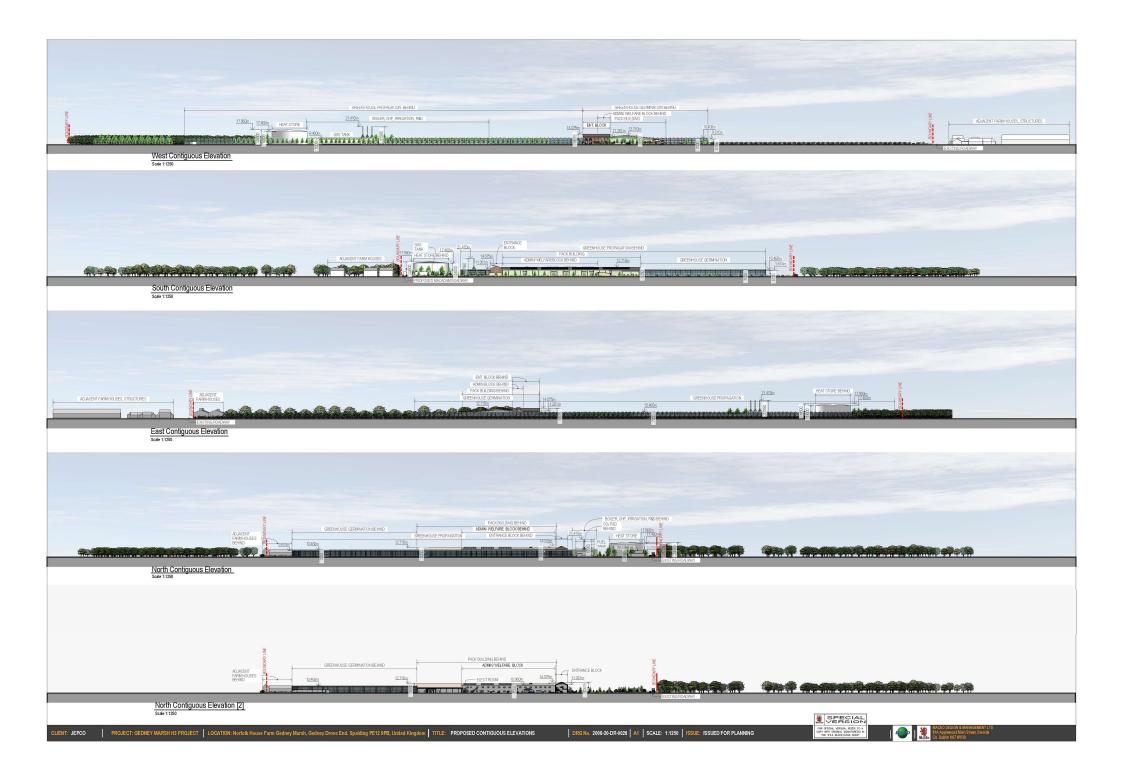

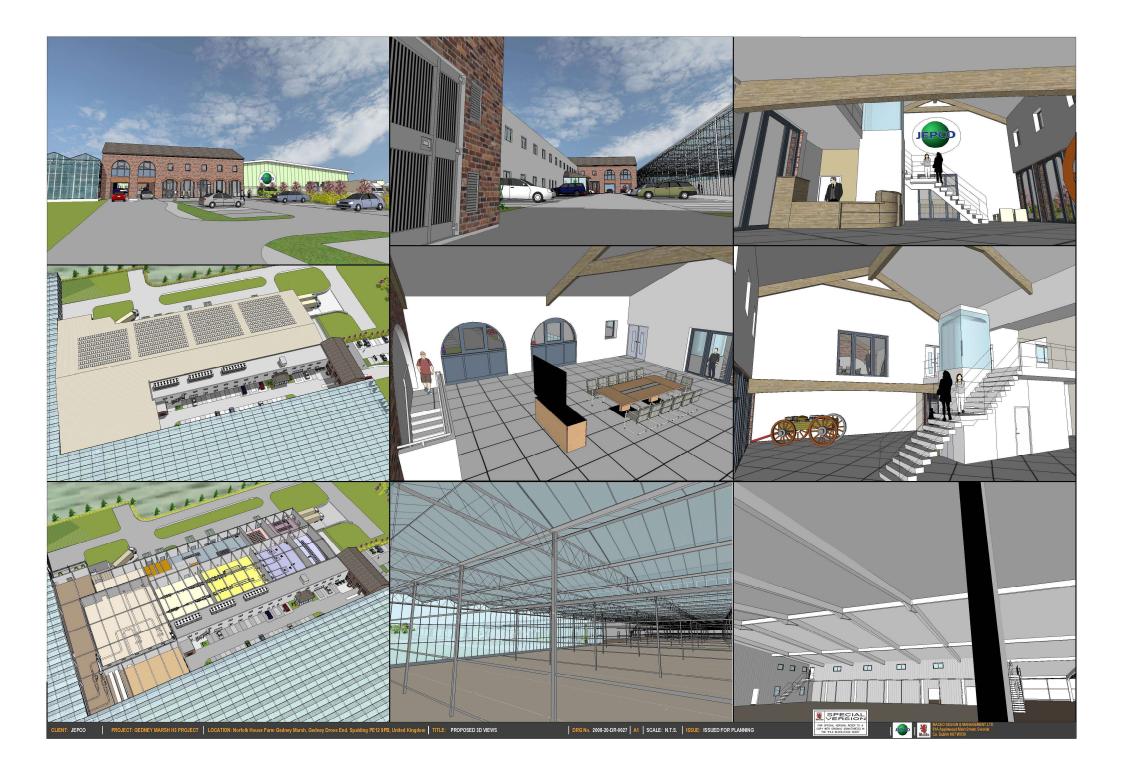





























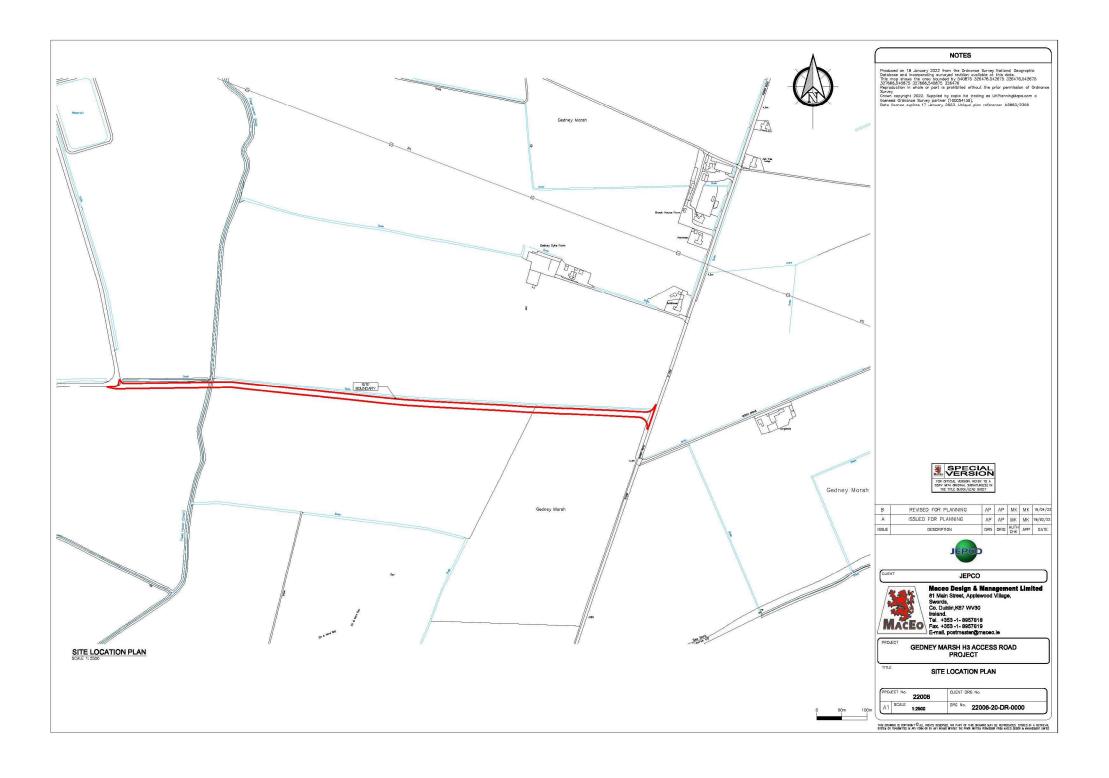

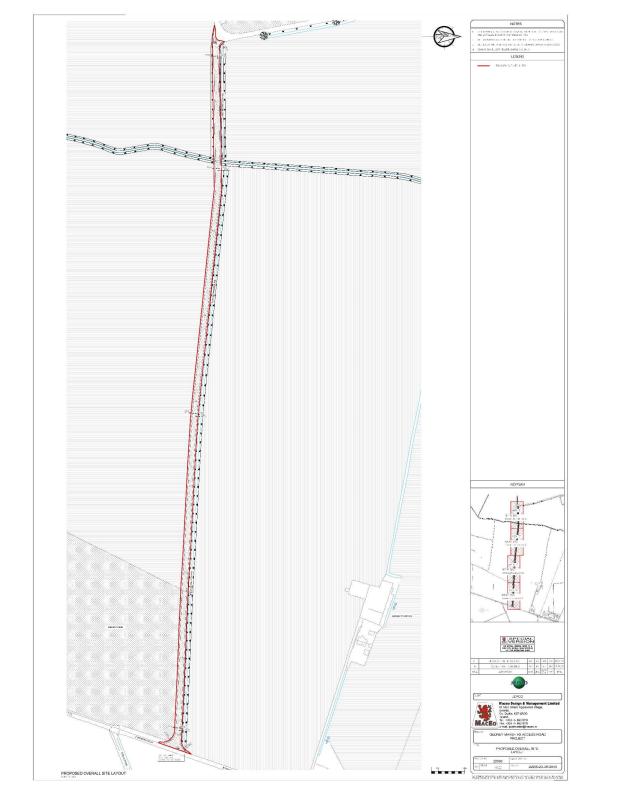

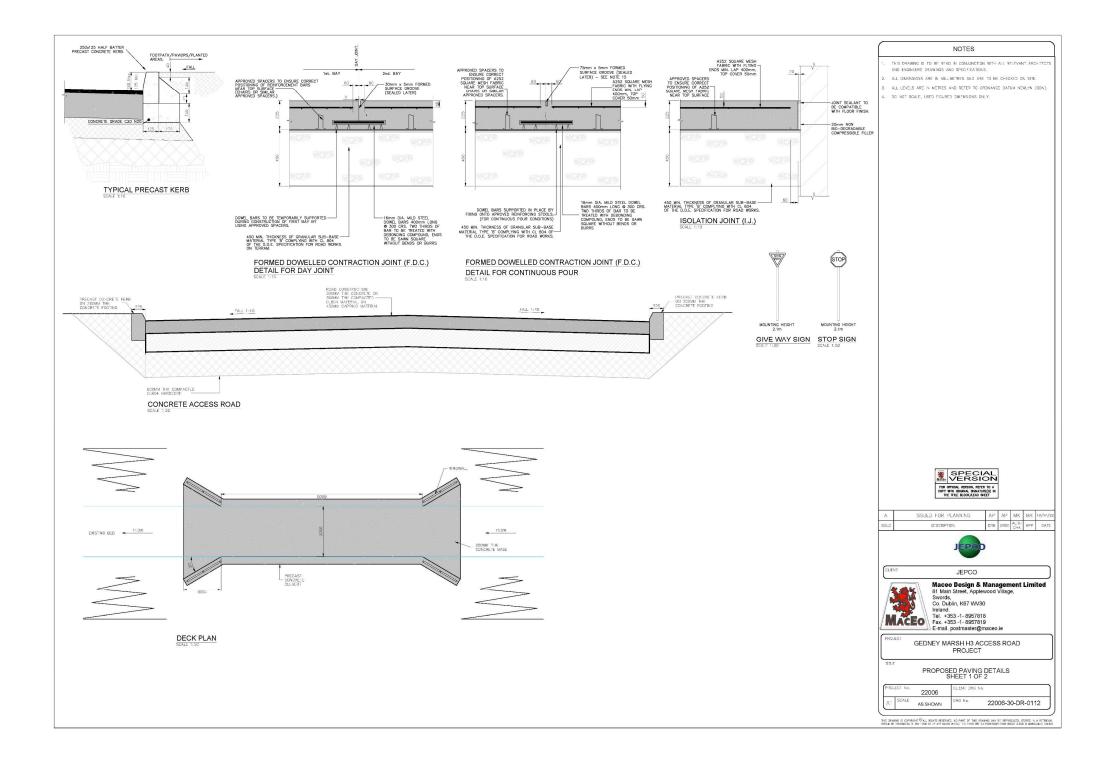

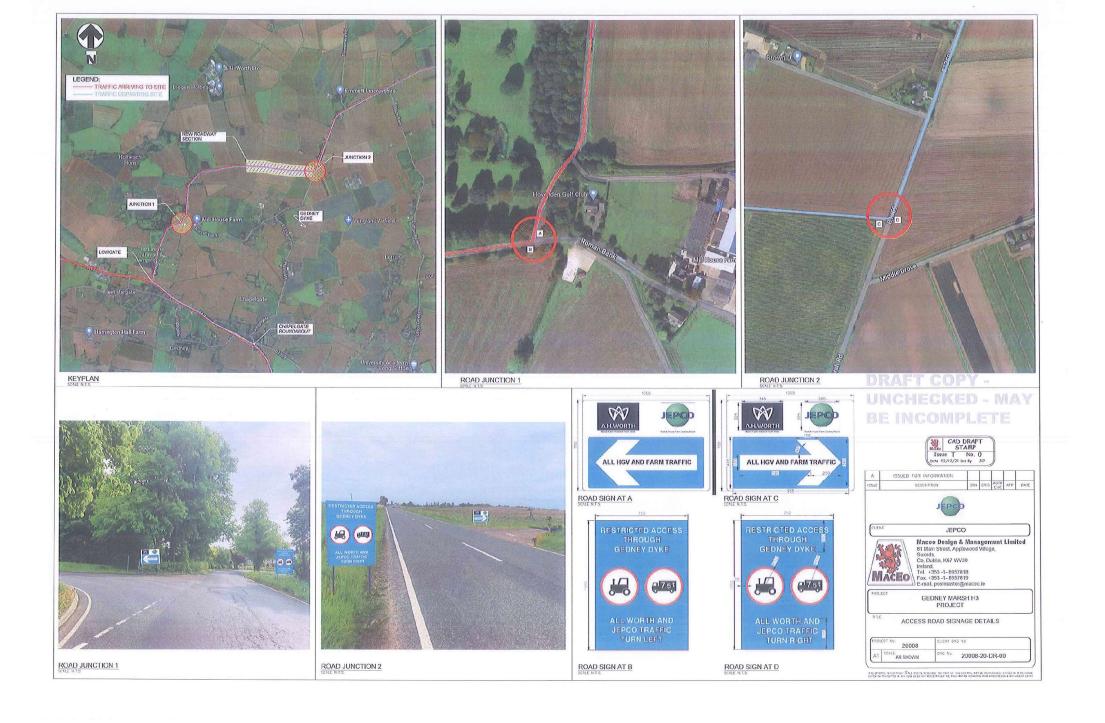










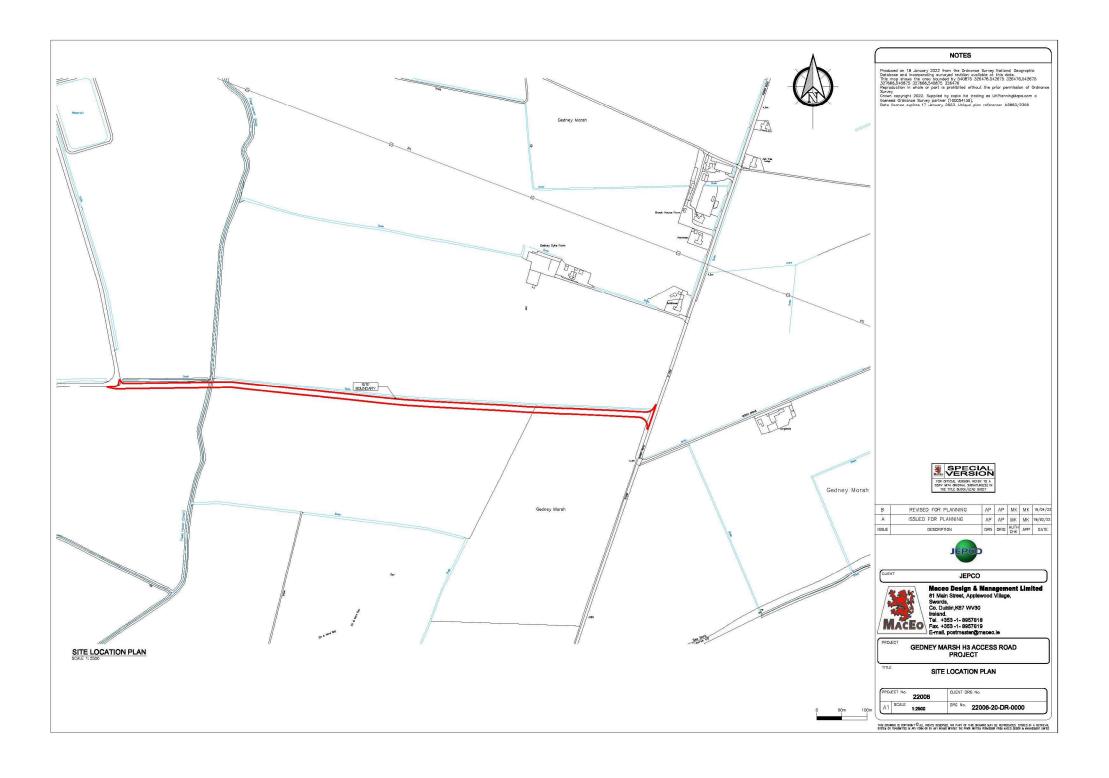









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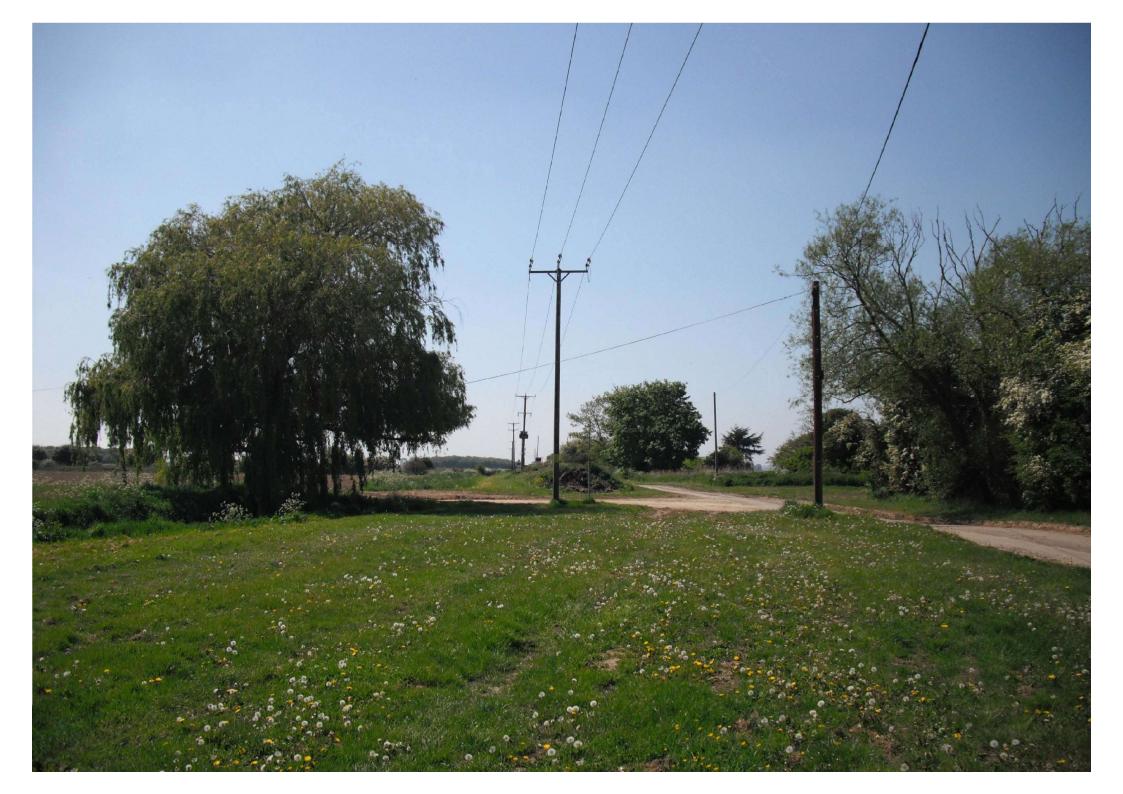


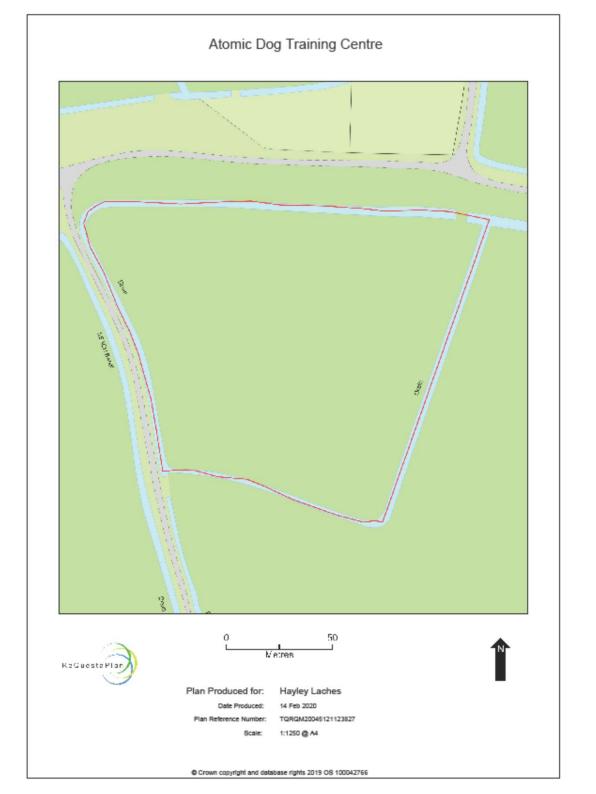

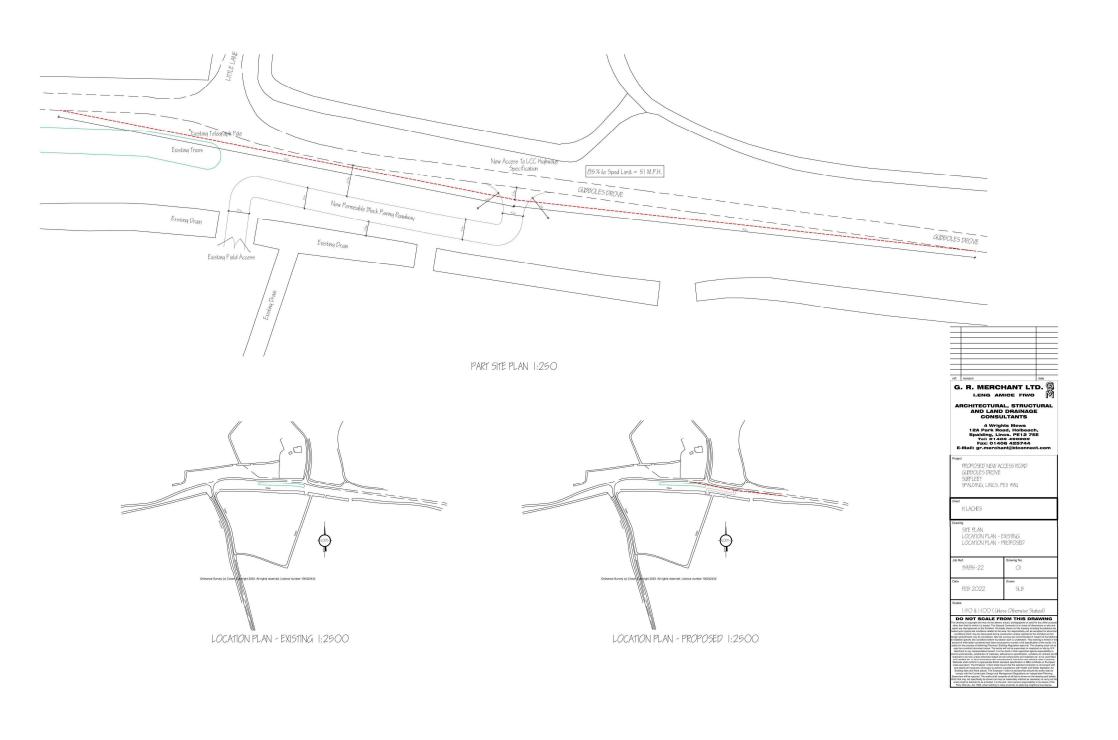















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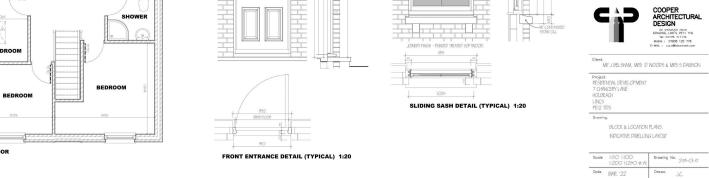


GARAGE

GROUND FLOOR

LOUNGE

FIRST FLOOR











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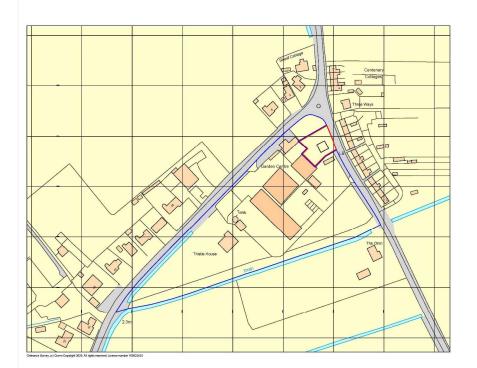
Proposed Refurbishment and change of use from residential to office accomodation at Silverwood Nursery, Sutton Crosses, Long Sutton, Spalding, PE12 9AU

O&L






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Site Location Plan Scale 1:1250


SCALE 1: 1250 0m 10m 20m 40m 60m 80m SCALE 1: 1 0m 8mm 10mm 40m 60m 80m





Site Block Plan Scale 1:500

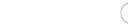

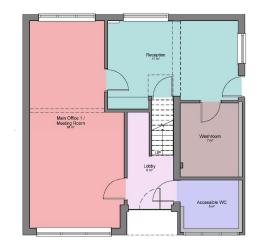

Ground Floor Level Plan as existing Scale 1:50

Scale 1 : 50

On 1m 2m 3m 4m 5m VISUAL SCALE 1:50 @ A1



First Floor Level Plan as existing Scale 1:50

X XXXXXXX Xxxx Ref. Date Description Oglesby & Limb Ltd Chartered Architect Suite 1, Market Chambers 12 Market Place, Spalding, Lines PE11 ISL Tel: 01775 761196 O&L e-mail: design@o-l-ltd.co.uk Tyrrell Properties Ltd

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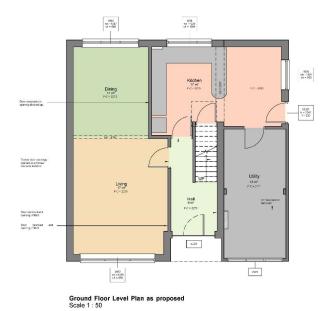
Proposed Change of Use from office to residential dwelling at Silverwood Nursery, Sutton Crosses, Long sutton, Splading, PE12 9AU.

Ground & First Floor Level Plans as existing

PLANNING APPLICATION ISSUE

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First Floor Level Plan as proposed Scale 1:50



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Tyrrell Properties Ltd

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Project:
Proposed Change of Use from office to residential dwelling at
Silverwood Nursery, Sutton Crosses,
Long sutton, Splading, PE12 9AU.

Drawing Title:
Ground & First Floor Level Plans as proposed

PLANNING APPLICATION ISSUE

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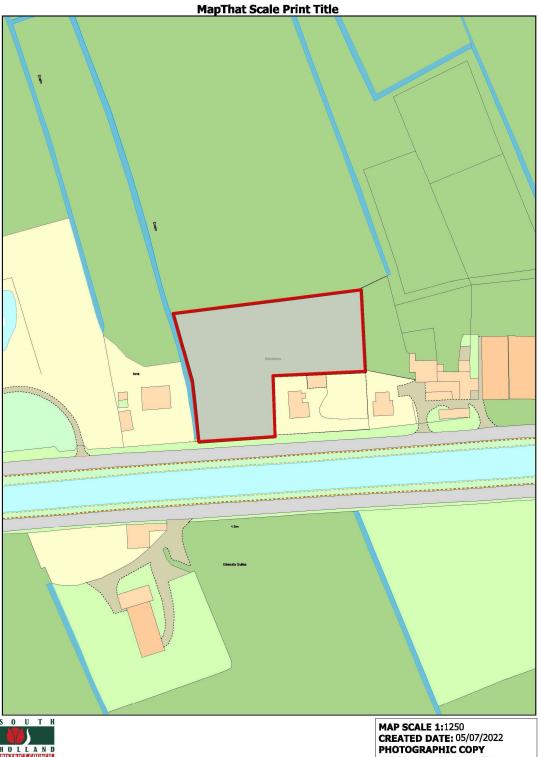







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A 11.04.2002 DG Dwellingreposi RIVISION DATE DRAWN DISCRIPTION



Mr & Mrs M Thomas

Proposed self-build home on land off Glenside North, Pinchbeck

DRAWING Site Layout

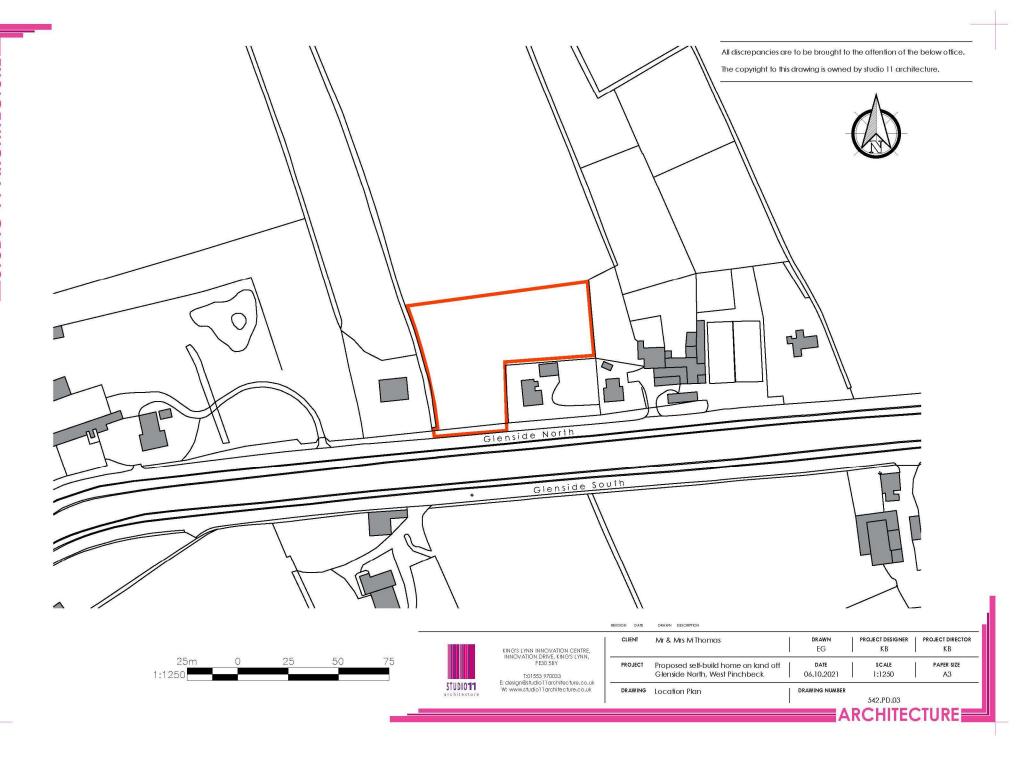DRAWN EG 06.10.2021 SCALE 1:200

542.PD.02



Glenside North, Pinchbeck
May 2022

Materials Key

- Black Standing Seam Cladding
- Grey Facing Brickwork
- Black Window/Doors
- Perforated Brickwork to Porch



South Elevation




East Elevation



North Elevation




West Elevation

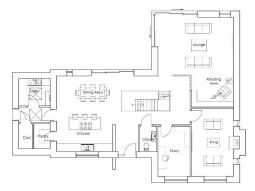

Ground Floor Plan



First Floor Plan

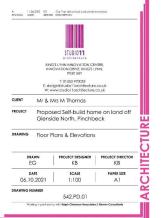

2m 0 2 4 6


New SuDS Water feature with marginal planting to increase

Wildflower Meadow providing a new habitat for pollinators such as Butterflies, Bees and Hover flies

Existing Tree Retained

Existing Hedge Retained

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Bat Boxes

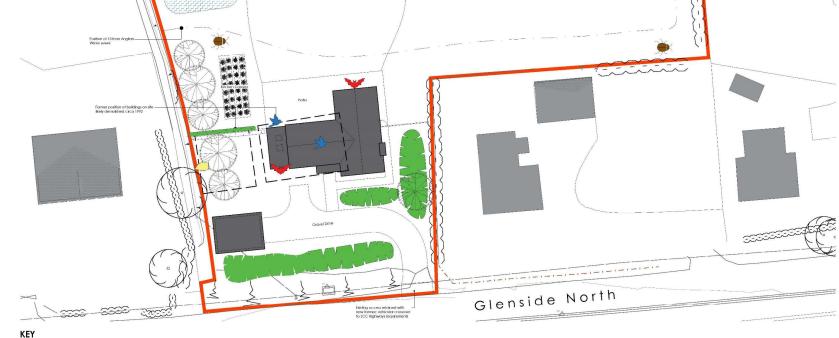Hedgehog Houses

Minibeast Habitats for inverterberates such as Beetles,

Woodlice, Centipedes and Millipedes

New Tree General Planting

New Native Hedge Planting

New Orchard Tree

New Shrub planting



STUDIO11

Mr & Mrs M Thomas

Proposed self-build home on land off Glenside North, Pinchbeck

DRAWING Ecology Measures

DRAWN EG PROJECT DESIGNER KB DATE 20.10.2021 1:200 DRAWING NUMBER

Kitchen Garden

542.PD.04

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KEY

Building highly insulated through the 'Fabric First' approach reducing Carbon through the life of the building

Photovoltaic Modules generating electricity for the home and selling surplus to the grid

Electricity battery storage retaining electricity on site during the day for use at night



Electric car charging point for charging minimum 2no. vehicles

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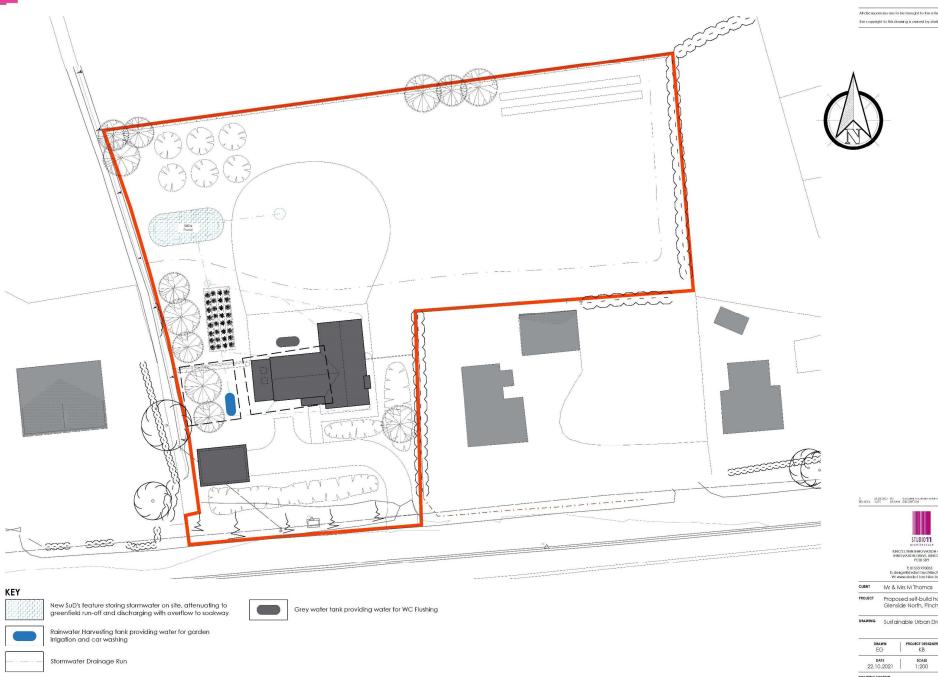
Mr & Mrs M Thomas

Proposed self-build home on land off Glenside North, Pinchbeck

DRAWING Carbon Reduction Measures

PROJECT DESIGNER | KB DRAWN EG 22.10.2021 3CALE 1:200 DRAWING NUMBER

542.PD.05





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Mr & Mrs M Thomas

Proposed self-build home on land off Glenside North, Pinchbeck

DRAWING Sustainable Urban Drainage Design

EG EG		PROJECT DESIGNER KB		PROJECT DIRECTOR
DATE	ï	SCALE	ı	PAPER SIZE
22.10.2021		1:200	l	A1

542.PD.06









Glenside North, Pinchbeck - View from South
April 2022



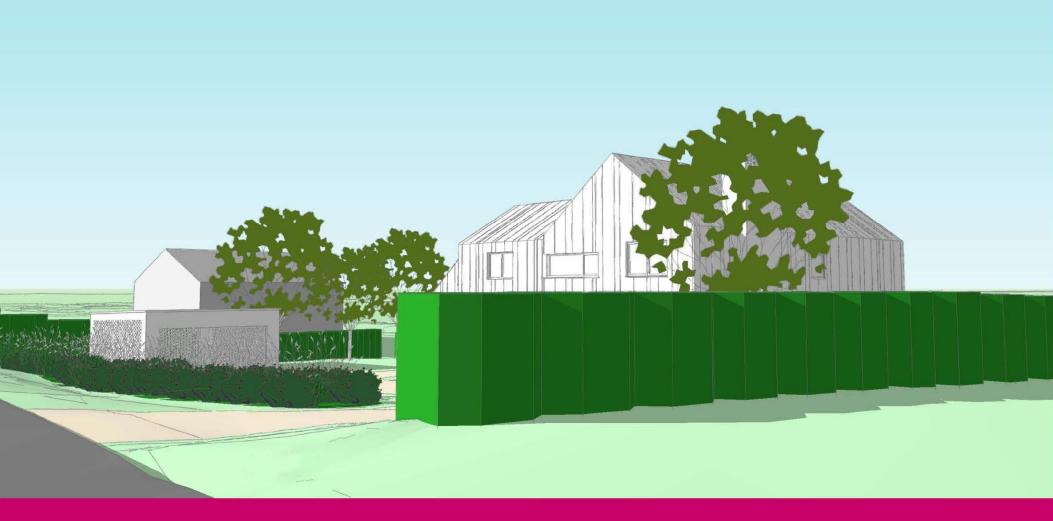



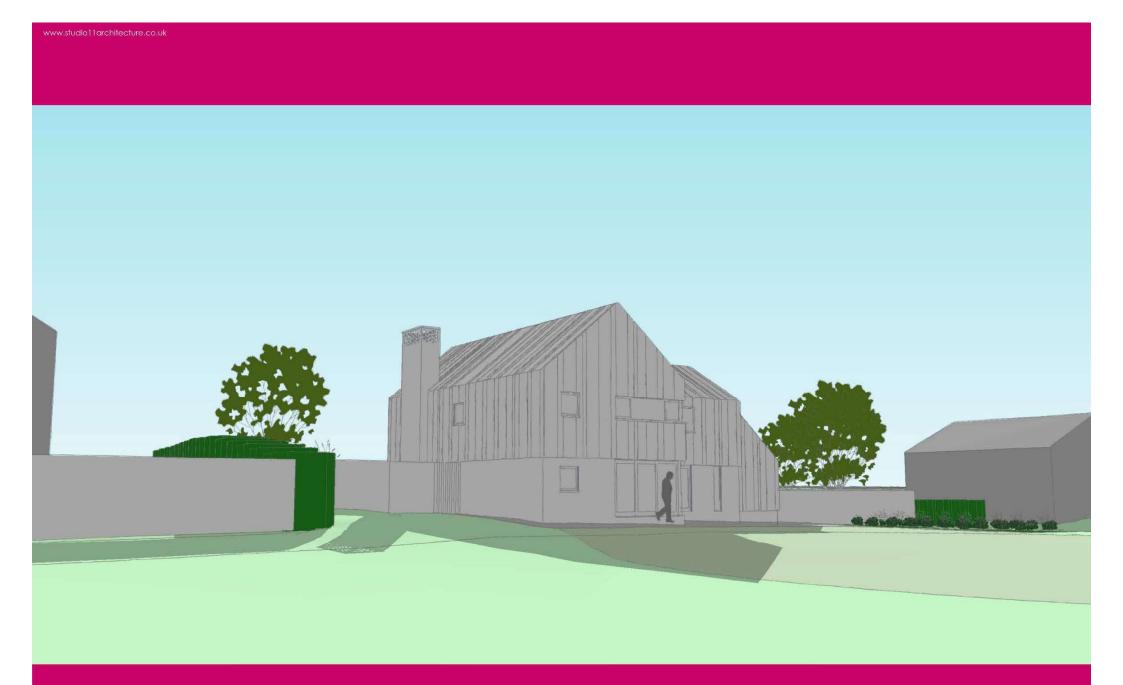














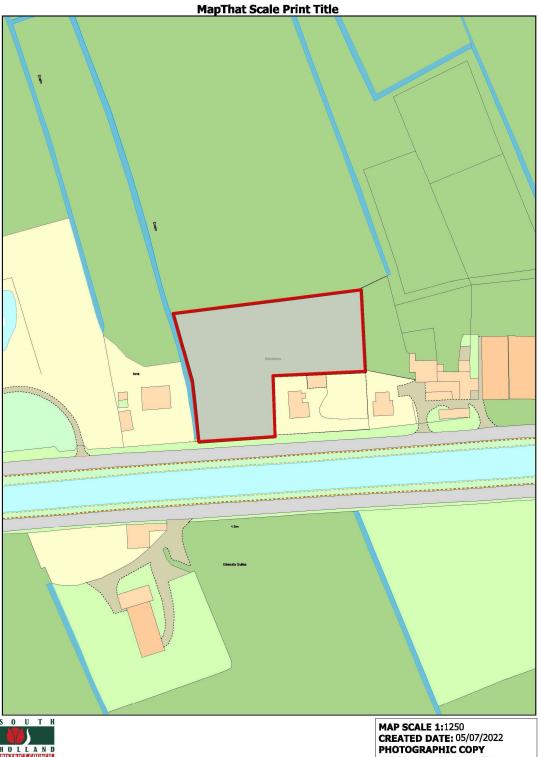




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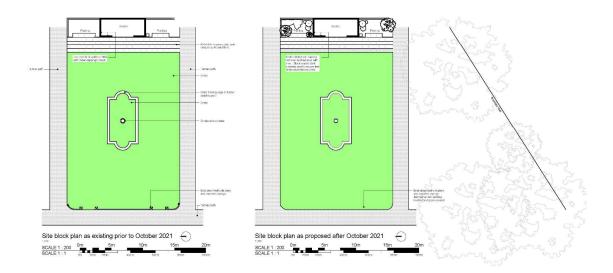




Image of shelter prior to works

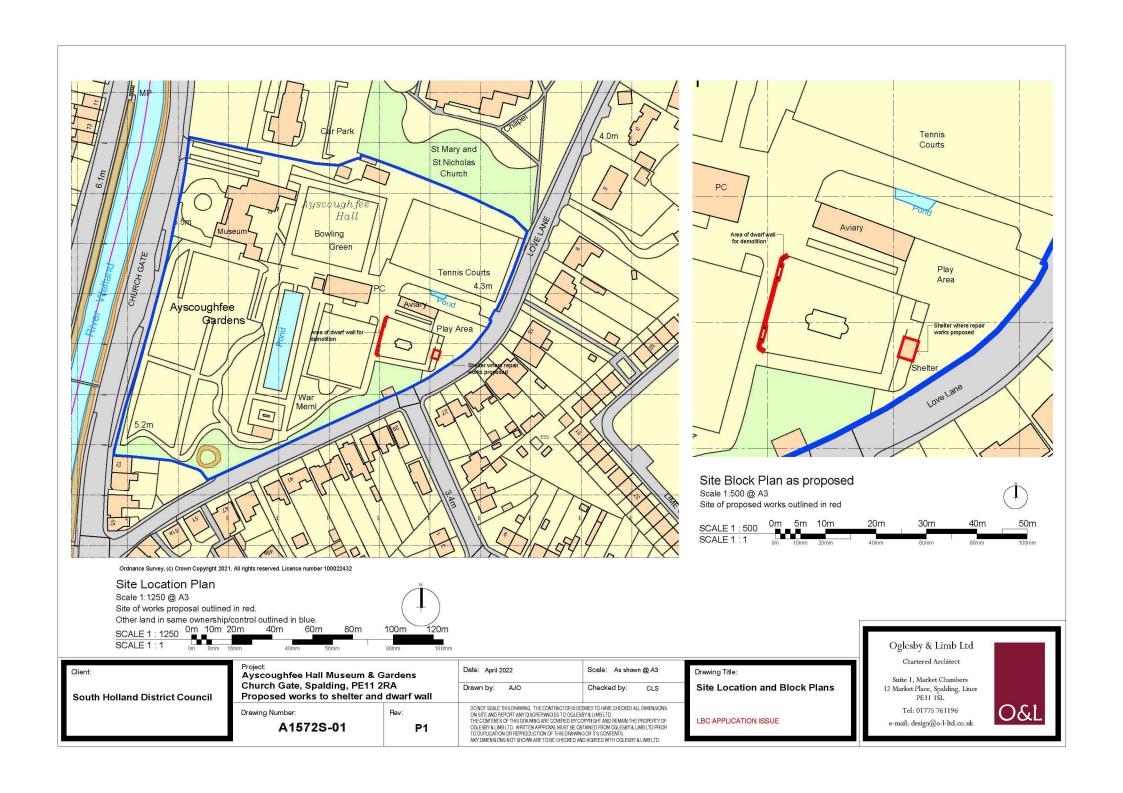Shelter repair photographs



Aerial image prior to demolition of dwarf wall



View from east prior to demolition, dwarf wall in centre ground



Image prior to works showing rotten timber plates



Image after to works showing new timber plates



Image after to works showing new timber plates

Dwarf wall demolition photographs



View from east after demolition.



Ground surface following demolition of wall



Ground surface following demolition of wall

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South Holland District Council

Ayscoughfee Hall Museum & Gardens Church Gate, Spalding, PE11 2RA

Proposed works to Shelter and demolition of Dwarf Wall

Drawin

Plans and photos as existing and as proposed


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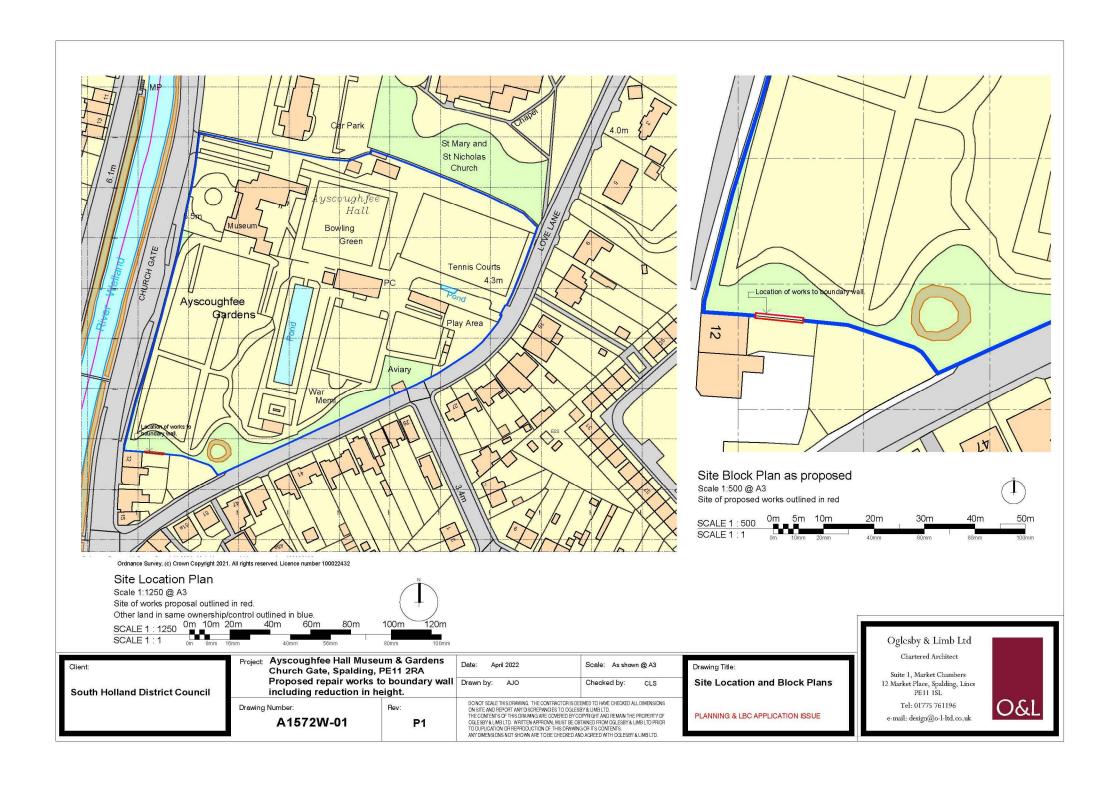





MapThat Scale Print Title Ayscoughfee Hall Bowling Green **Tennis Courts** PC Play Area Aviary War Meml S O U T H MAP SCALE 1:500 CREATED DATE: 04/07/2022 PHOTOGRAPHIC COPY HOLLAND DISTRICT COUNCIL LIABLE TO DISTORTION © Crown copyright and database rights 2018 Ordnance Survey 100018351. IN SCALE





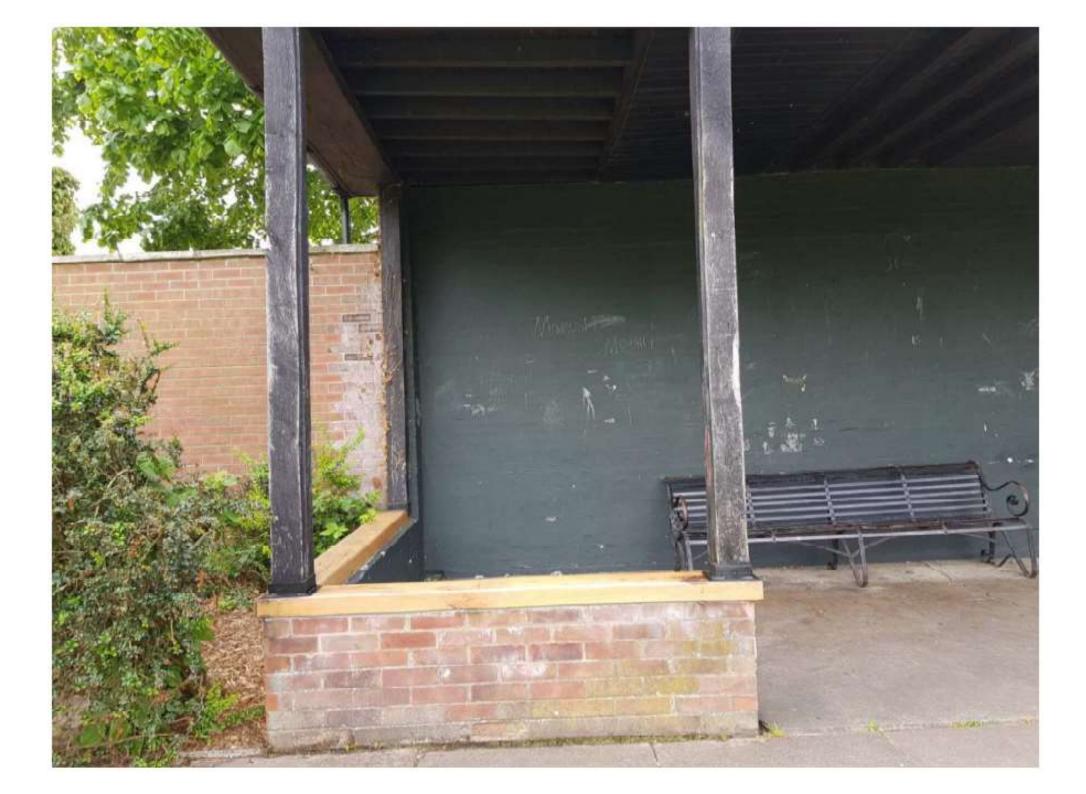

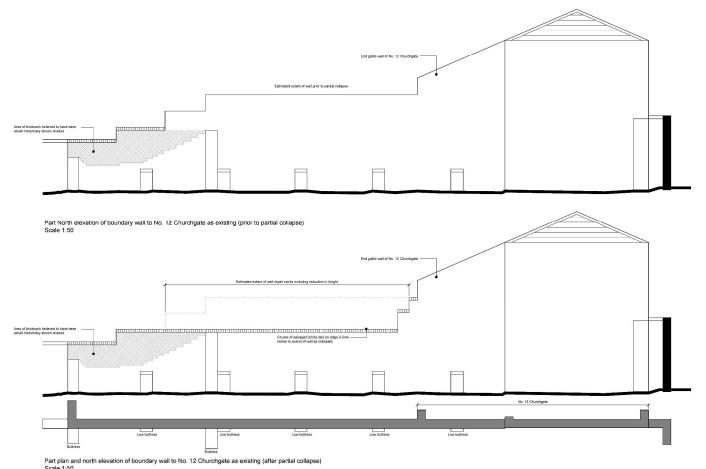

Scale 1:50





View of wall from SE prior to partial collapse and rebuild



View of wall from SE after partial collapse and rebuild




View of wall from N after partial collapse and rebuild



Detailed view showing capping course set in lime mortar



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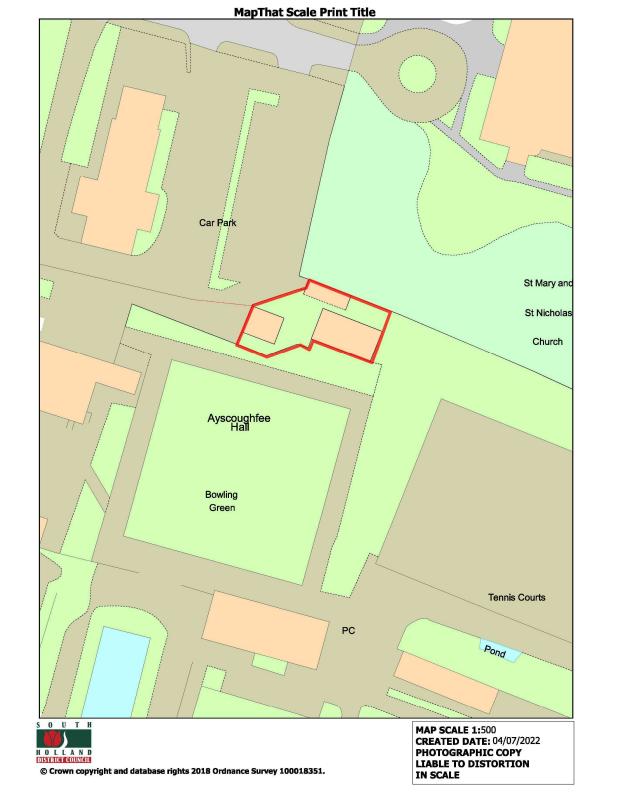


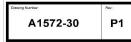












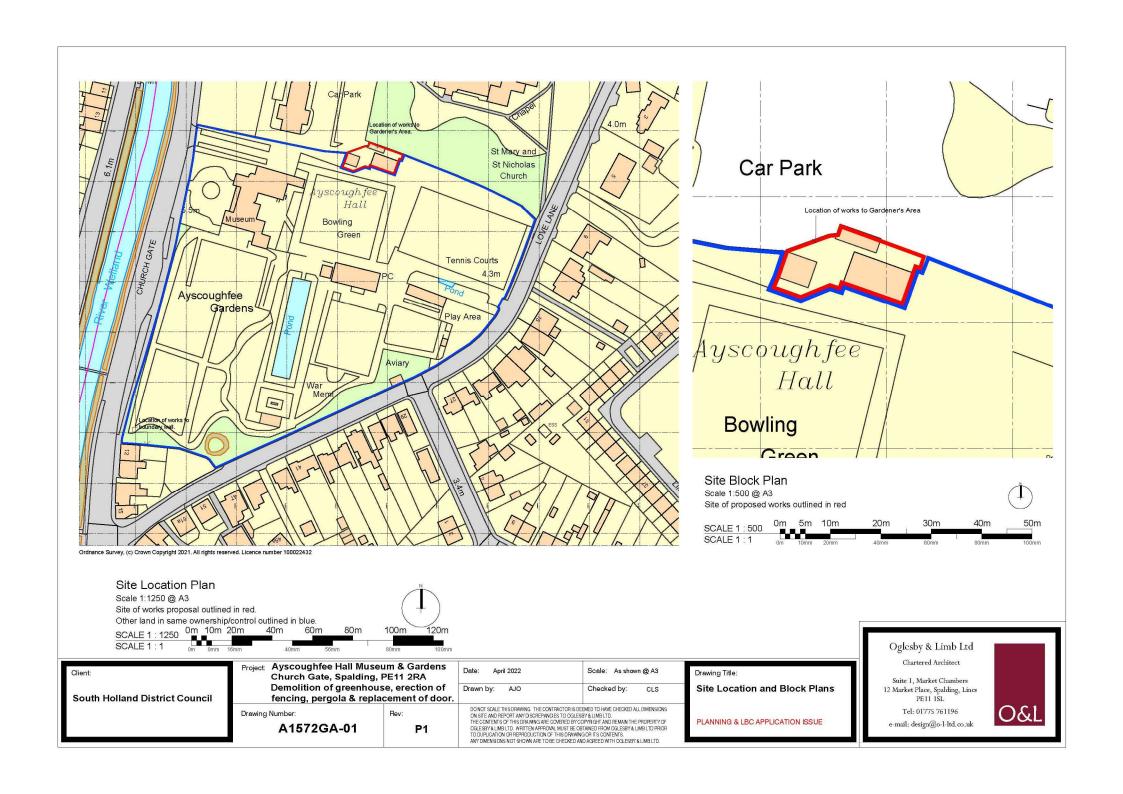


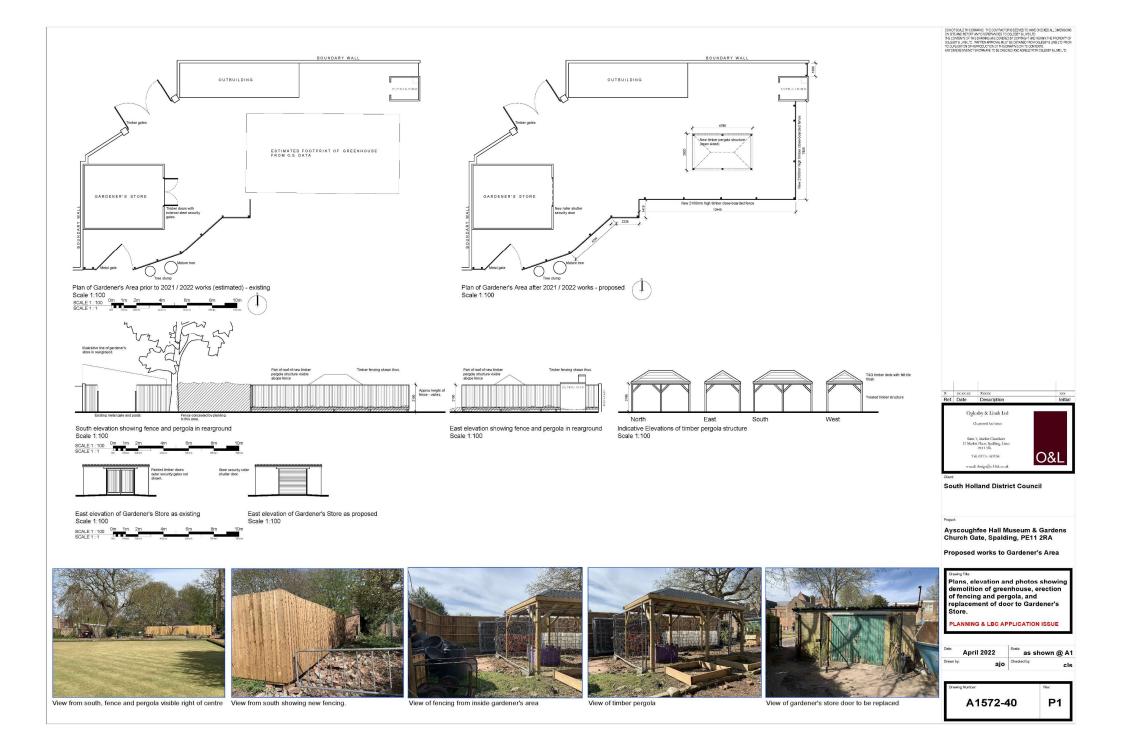







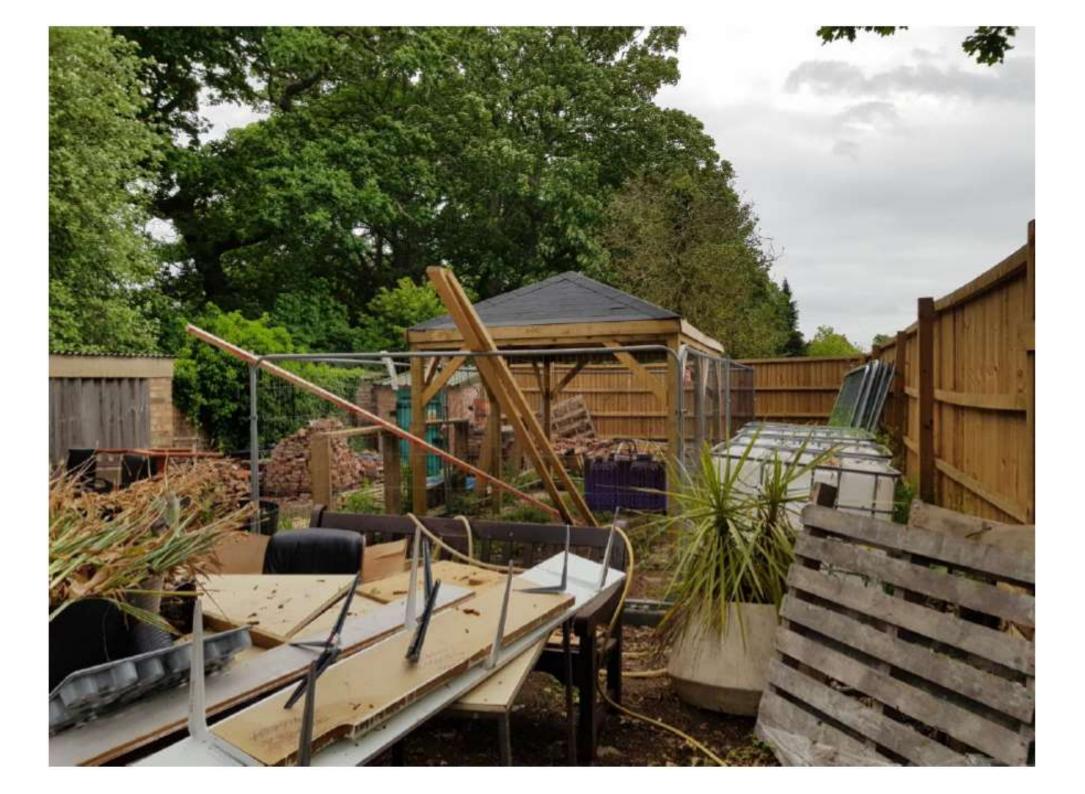


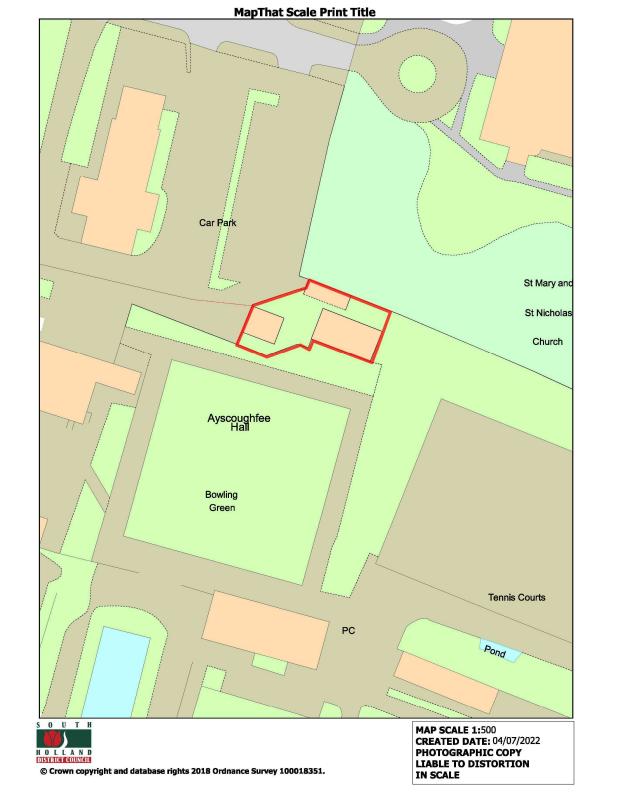



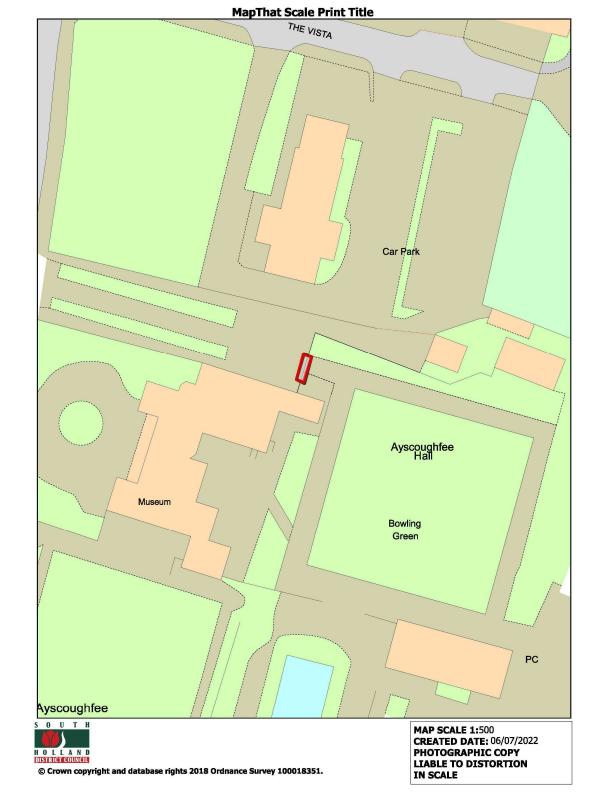

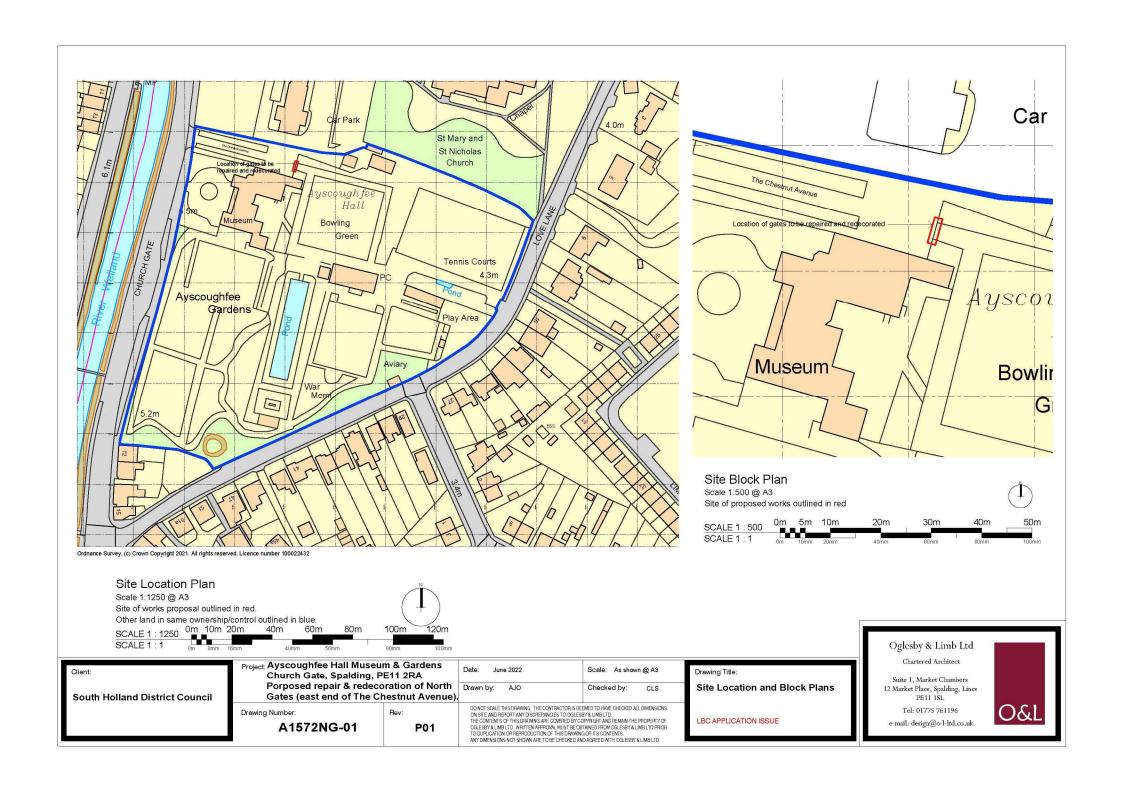

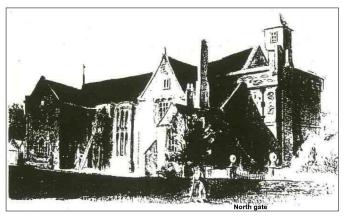

Anonymous image of Ayscoughfee Hall from 1821



North pillar - top section rebuilt

Note
Lower section in finer guage brickwork with white lime
mortar with aggregate exposed.
Upper section has wider mortar joints, mortar is more grey
in colour and smoother in texture.
Conclusion. Jupper section has been rebuilt recently.



Ground-mount pivot point at north pillar Note: Non-adjustable fitting



Gates viewed from the West Gates set between brick pillars, parts of which have been re relatively recently.



Gates viewed from the East



South pillar - top section rebuilt



Fixed hinge point on north pillar Note: Fixed hinge does not allow for any realignment of the gates so they cannot be pulled out at the top to prevent clashing at the meeting stiles.



Lock box on south gate Note: Internal mechanism of lock is missing and out lock box is



Fixed hinge point on south pillar Note: Fixed hinge does not allow for any realignment of the gates so they cannot be pulled out at the top to prevent clashing at the meeting stiles.



Ground-mount pivot point at south pillar Note: Non-adjustable fitting



Head detail over meeting stile - North gate Note: Tape shown for scale



Note: Tape shown for scale



Head detail over meeting stile - South gate Lock box meeting stile - North gate Note: Lockbox damaged and gate frame badly distorted.



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Tel: 01775 761196 e-mal: design@o-l-ltd.co.u South Holland District Council

Ayscoughfee Hall Museum & Gardens Church Gate, Spalding, PE11 2RA

Proposed works to North Gates (at end of The Chestnut Avenue)

Photographs of gates as existing LBC APPLICATION ISSUE

June 2022		as shown @ A1	
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A1572-50

North gate (from west)




View of gates from west (the Chestnut Avenue) - showing visible defects and repairs

South gate (from east)



View of gates from east (inside Ayscoughfee Gardens) - showing visible defects and repairs

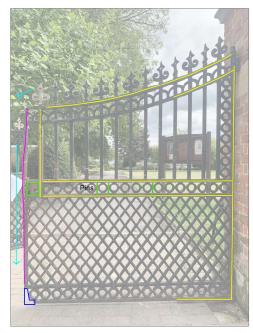

North gate (from east)

South gate (from west)

Gate condition - the issues:
The existing gates date from at least the early 1820s and as such have significant historic and architectural value. The following issues are however evident which hinder the movement and securing of the gates and raise some concerns regarding their long term longevity.

- The paint finishings are in poor condition, much of the black paint is peeling to reveal a form of red oxide primer beneath. The decorative outer coating is not therefore providing the optimal level of protection to the iron substrate beneath.
- The gates will not close correctly, this is due to distortion within the gates and in particular the south
- The lock box is not functioning and consequently the gate has been secured by a chaln which has further damaged the painted surfaces.
- Both gates have been repaired historically. Both faces of both gates have had strengthening straps applied, these have been fixed using exposed studs. There is a considerable amount of strapping which would suggest significant failure, particularly in the
- would suggest significant rationer, participant in the outer frame of each gate.

 5. On the south gate 3 vertical pins have been installed within the central rail, again suggesting a interim
- repair.

 6. The north gate has hairline cracks running horizontally at mid-rail level and at an angle of 45 degrees descending from the lock box. These fractures appear to extend through the full thickness of the iron. There appears to be general distortion in both gates, but particularly the south gate. It is suspected that the shear weight of each gate is either causing or significantly contributing to this.
- significantly contributing to this.

 The mortar pointing within the brick pillars is evidence of the relatively recent rebuilt of part of the gates supporting posts. The hinge fittings appear to be a later addition. These do not allow for any adjustment meaning that distortion or movement within the gates cannot easily be accommodated.

Proposals - the aims: The applicant (SHDC) recognizes that the gates need maintenance and repair to address a number of the items raised above and to ensure their longevity. It is recognized that the gates have significant value both historically and architecturally and therefore the approach taken is to repair and conserve rather than replace. The aims are therefore as follows:

- as tollows.
 1. To repair the gates and eliminate distortion as far as practically possible such that the gates can be closed correctly and that they can be used to fulfil their original purpose.
- original purpose.

 To repair cracks and fractures within the gates to minimize the risk of further deterioration.

 To retain as much of the the original fabric as it is practical to achieve, whilst ensuring the structural integrity of the gates.
- 4. To repair the looking mechanism such that this can be used to secure the gates. Should the existing lock components be missing or damaged beyond repair then to install new, sensitive to the design of the
- gates.
 5. To remove all previous decoration, prime and redecorate the gates to provide optimum protection to the ironwork.
- To return the gates to their original colour, as they would have appeared in the early 19th C.

Fracture / crack completely through member shown thus.

Previous repair - straps pinned / welded to iron.

Other damage - some previously repaired

Direction of general distortion.

Significantly distorted member

---- Incomplete / missing frame section?

Note double lock box (one to each gate leaf) - both non-operable.

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South Holland District Council

Ayscoughfee Hall Museum & Gardens Church Gate, Spalding, PE11 2RA

Proposed works to North Gates (at end of The Chestnut Avenue)

Annotated photographs showing existing visible defects and previous repairs.

BC APPLICATION ISSUE

June 2022 as shown @ A1

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P01

Investigations and outcomes:

Prior to developing proposals it was necessary to investigate various aspects of the gates to establish basic and detailed facts. This was necessary in order to assess the project

Paint Analysis

The existing paint is black in colour but is flaking extensively revealing a red oxide primer beneath. During investigation works no historic photos were discovered that could confirm original paint colour, therefore a full paint analysis was undertaken to establish what evidence remains on the gates. Paul Croft of Lincoln Conservation was commissioned and attended site to take samples on 21st April 2022. The report is provided as part of the accompanying application documents, from this the following was derived

- 1. Paint sample evidence supports the date for the gates
- as being likely early 9th Century.

 The gates have been painted with black oil paints throughout their history.
- 3. The scroll tops have been picked out in gold paint, but this is a recent feature dating from probably no earlier than 1980

Lincoln Conservation were also able to advise on suitable redecoration and in this respect suggested the following: Primer - Rust-oleum Zinsser Metal Primer

Top coats - Zinsser AllCoat Exterior Gloss (water-based)

Overall Gate design
The majority of evidence found to date the gates is in map form, however there is an anonymous painting of the east side of Avschoughfee Hall dated 1821 that appears to show gates of the extant design. Since the paint analysis findings support this date, and in the absence of any further evidence, it is concluded that the gates are original and at least early 19th Century.

With respect to the general condition of the gates, these were visually inspected in some detail. Numerous areas of damage and defect were discovered and these are recorded on the application drawings. It is acknowledged that some damage may have been missed, some may not be visible from the exterior or may be concealed by paint and general During this process, input and advice was sought from Chainbridge Forge in Spalding as they have a strong knowledge of metalworking and a experienced-based practical knowledge of what is achievable.

Proposed works - south gate:

- South gate to be carefully removed from hinge points to allow transfer to workshop.
- Existing paint finishes to be removed using controlled media blasting. Media to be selected to minimize surface damage to iron
- Historic repair strapping to be removed.
- Distorted, cracked outer frame member of gate to be carefully cut away from central lattice and ring ironwork.
- 5 Existing lock box to be assessed for damage and reused if repairable. Should this not be the case then new to be fabricated to match existing in all respects
- Existing lattice and ring ironwork to be brought back into flat alignment and repaired locally by installing plns tapped and dled. Lock edge of gate (lattice work etc) to be cut back nominally 20mm in readiness to attach new perimeter frame. This as an allowance to move the meeting stiles apart slightly to allow the gate to close properly (distortion currently prevents
- New steel perimeter frame to be measured and
- constructed to replace former. New steel perimeter frame to be attached ensuring that original details within centre of gate and along top are retained in situ.
- Gate to be prepared and redecorated as specified
- 10. Gate to be returned to site and rehung using
- adjustable hinges in place of existing fixed hinges within pillar brickwork.

 11. Any disturbed brickwork to be made good reusing existing bricks set in lime mortar to match existing in
- Gates to be adjusted and lubricated on site to ensure correct and full operation

Proposed Redecoration works to both gates:

Following removal of existing paint and primer layers and suitable preparation of metal surfaces, the gates are to be redecorated in black throughout, in order that their original appearance can be best replicated. Paint system to be the following or equal approved:

Rust-oleaum Zinsser Metal Primer Top Coate Zinsser AllCoat Exterior Gloss (water


All works to be in strict accordance with manufacter's recommendations




View of gates from west (the Chestnut Avenue) - showing visible defects and repairs



View of gates from east (inside Ayscoughfee Gardens) - showing visible defects and repairs

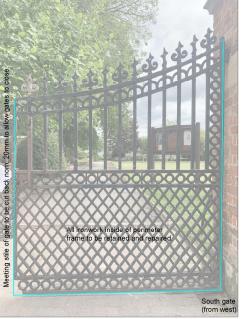

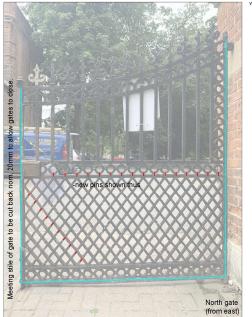

Key findings of the visual investigation.

- The gates have distorted over time particularly the south gate and have been repaired on at least one occasion. It is suspected that this distortion is either
- caused or worsened by the self-weight of the gates.
 The central iron sections of the gates (latticework etc) have fractured and cracked in areas, though overall the historic fabric remains present and intact. It is suspected however that this has structural integrity
- only as infill.

 The outer frame of both gates shows the greatest degree of distortion and has evidence of cracking.

 The repair strapping that has been added to the gates is all attached to either the mid-rail or the perimeter frame (side and base members) of both gates. This suggests that the outer frame has failed historically and that there has been a problem with both distortion and failure for a significant period of time.
- The hinges appear to be a later addition and do not allow for any adjustment of the gates to accommodate distortion or mis-alignment.

- The gates appear to be original and therefore the initial assumption that the fabric is of architectural and historic interest, worthy of conservation rather than replacement, is correct.
- The historic paint evidence found provides information about the original colour and finish and allows reasonable replication of the original appearance as
- part of these works.

 The central ironwork within the gate is original and intact though it has suffered fractures in numerous locations. Discussions with Chainbridge Forge have indicated that this could be saved and the cracks could be secured using pins. This would retain the original fabric, address the breaks and minimize further deterioration, though the lattice etc would require structural support to its perimeter to prevent further damage occurring in daily use.
- The perimeter frame of both gates has fractured in multiple locations and has been heavily strapped historically. This has however not prevented distortion to the extent that it is no longer possible to close the gates. In consultation with Chainbridge Force it is not consider feasible to further repair the outer frame in a satisfactory manner that will afford the required structural support for the intill, nor is it feasible to remove the distortion within the existing frame. It is however noted that the curved upper frame members for both gates could be retained and
- The hinges and floor pivot points for the gates are all fixed and allow no adjustment to stop the gates from clashing. This presents an ongoing problem.

Proposed works - north gate:

- North gate to be carefully removed from hinge points
- to allow transfer to workshop.

 2. Existing paint finishes to be removed using controlled media blasting. Media to be selected to minimize
- surface damage to iron.
 Historic repair strapping to be removed.
- Distorted, cracked outer frame member of gate to be carefully cut away from central lattice and ring
- Existing lock box to be assessed for damage and reused if repairable. Should this not be the case then new to be fabricated to match existing in all
- respects.

 Existing lattice and ring ironwork to be brought back into flat alignment and repaired locally by installing pins tapped and died. Lock edge of gate (lattice work etc) to be cut back nominally 20mm in readiness to attach new perimeter frame. This as an allowance to move the meeting stiles apart slightly to allow the gate to close properly (distortion currently prevents
- New steel perimeter frame to be measured and constructed to replace former.
- New steel perimeter frame to be attached ensuring that original details within centre of gate and along top are retained in situ.
- 9. Gate to be prepared and redorated as specified elsewhere

 10. Gate to be returned to site and returng using
- adjustable hinges in place of existing fixed hinges within pillar brickwork.
- Any disturbed brickwork to be made good reusing existing bricks set in lime mortar to match existing in all respects. 12. Gates to be adjusted and lubricated on site to ensure
- correct and full operation. - Preliminary locations for proposed tap and
- Extent of distorted and fractured perimeter frame to be removed and replaced with new in steel.

die pin connections.

DO NOT SCALE THIS DRAWNING. THE CONTRACTOR IS CEIMED TO HAVE CHEDNED ALL DIMENSIONS ON SITE AND REPORT AND DISCONDERS AND SITE OF THE PROPERTY OF COLORS AND SITE OF THE PROPERTY OF THE PROPERTY



South Holland District Council

Ayscoughfee Hall Museum & Gardens Church Gate, Spalding, PE11 2RA

Proposed works to North Gates (at end of The Chestnut Avenue)

Annotated photographs showing repair and conservation proposals. LBC APPLICATION ISSUE

as shown @ A1 June 2022 ajo cls

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P01









