

Welcome to the Planning Committee

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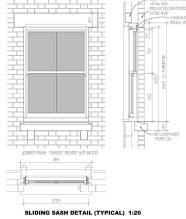


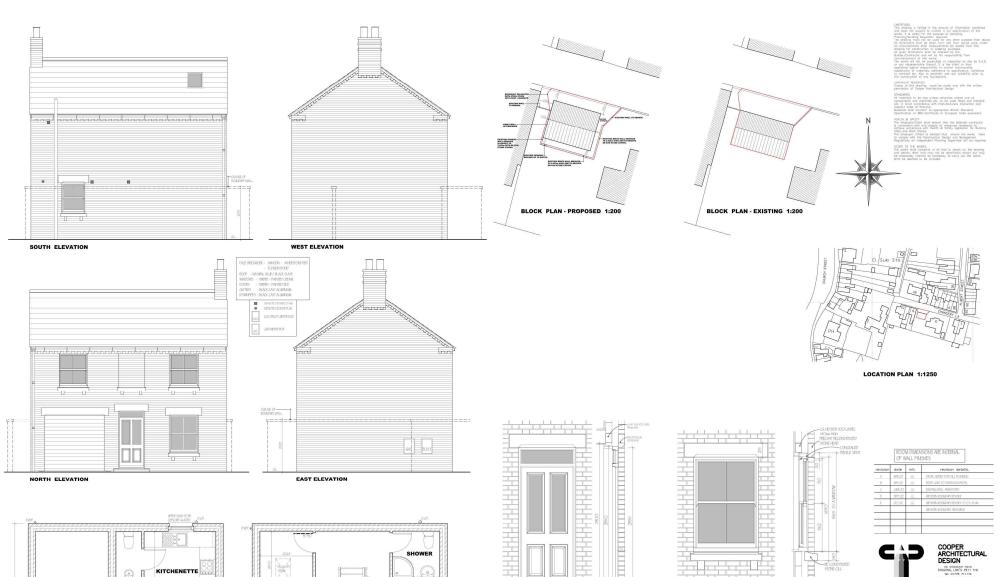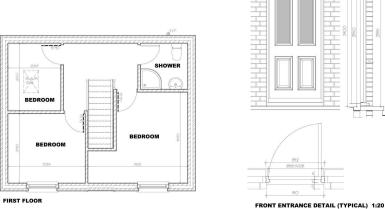

GARAGE

GROUND FLOOR

LOUNGE



evision	date	init:	revision details.
A	WE22	16.	DERNE ADDED FOR HULL PLANNING
Þ	W60.22		ROOF LIGHT TO SOURLELEVANCIN.
jc.	JAE 22	JG.	DISHNA WALL ANNOTATED.
0	901.22	JE.	WESTERN DOUNDARY REVISED
E	OCT 22	JG.	WESTERN POUNDARY REVISED TO D.S. PLAN
			WESTERN BOUNDARY (TEARWEN)
C	A	.	COOPER ARCHITECTURAL DESIGN SPAURIC (1985 PRT1 174
			Mobile : 07808 125 778
Project			E-MAL: cast@btconnect.com
Project RESIDE	NTIAL DI ACERY LI ACH	EVELOP	WRS ID WOODS & MRS 5 DAWSON
Project RESIDE 7 CHW HOLDE LINCS	NHIAL DI ACERY LI ACH DS	EVELOP	WRS ID WOODS & MRS 5 DAWSON
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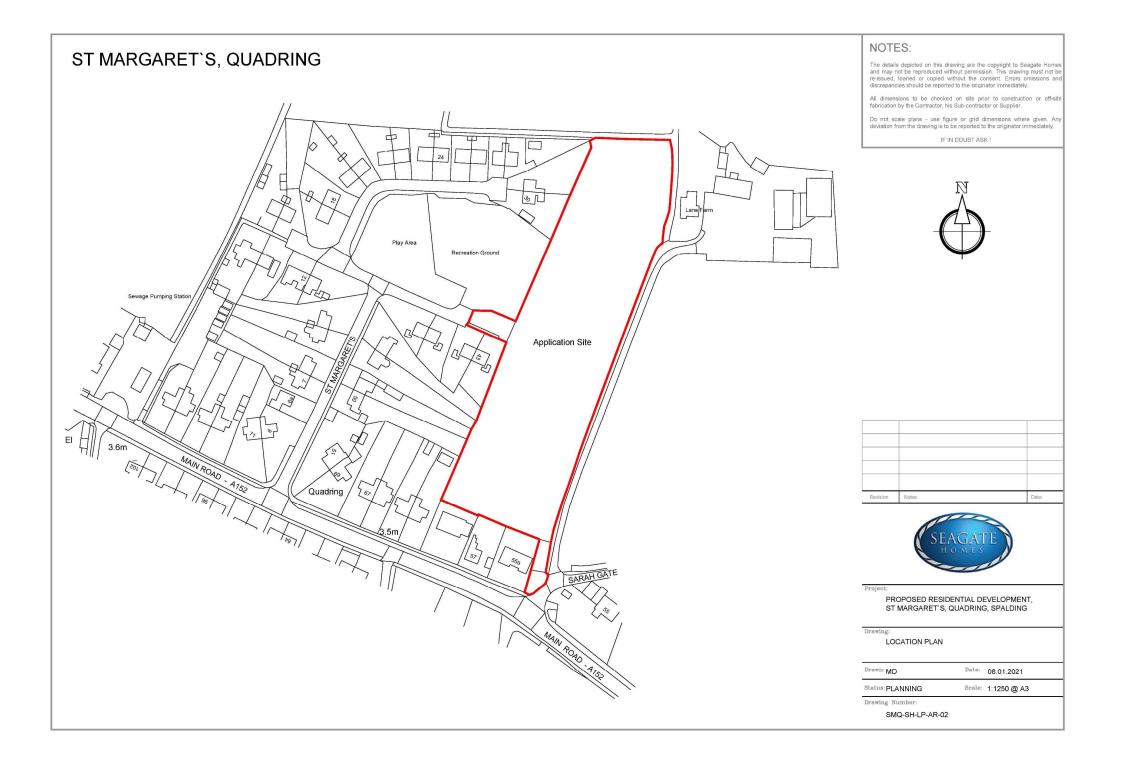




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C Existing tree indicated in rio No 48 St Margarets B Amendment to parking for plots 8, 9, 30, 31, 34-36. (as discussed with Pfanning services) Amendments to layout as requested by Planning Services. Legands updated.	25.10.22 18.10.202 9.8.22
B Amendment to parking for plots 8, 9, 30, 31, 34-36. (as discussed with Planning services)	
	25.10.22
	25 10 22



PROPOSED RESIDENTIAL DEVELOPMENT, ST MARGARET'S, QUADRING, SPALDING, LINCS.

SITE LAYOUT (PLANNING)

Drawn: MD	Date:	04.08.2021
Status DLAMMING	Spale	1,500 @ 41

Drawing Number:

SMQ-SH-SL-AR-01 - C

ST MARGARET'S, QUADRING.

Landscape Specification - Plot Landscape

Tripsoil

It is expected that all soils will be derived from the site. However, should additional soils be required, all soil except for wildflower seed areas, is to be imported to meet BS topsoil requirements for 'General Purpose' use. New shrub beds are to receive topsoil minimum 450mm depth after settlement. Turf and amenity grass seeded areas are to receive minimum 150mm depth of topsoil after settlement.

Trees Root barriers are to be employed near services. Landscape contractors are to check the locations for all existing and proposed services prior to undertaking excavation works.

All standard and multi-stem trees are to be planted in separate pits 1m x 1m x 900mm which shall be backfilled with a mixture of approved top soil and tree and shrub planting compost at a rate of one part compost to two parts topsoil. Each tree shall be planted centrally within the pit to the original root collar and secured by underground guys. Trees within areas of open space and amenity areas shall be fitted with a watering tube such as Root Rain 'Metro' (supplied by Greenleaf), or similar approved.

After planting all trees shall be watered-in and a mulch layer of 1m diameter approved forest bark spread over the tree pit to 50mm depth. A biodegradable tree shelter will be fixed to the base of each tree to protect it from

Ornamental
Ornamental hedgerow trenches shall be dug to a 450mm depth and 450mm width. The base of which shall be broken up before returning the approved topsoil backfill mixture to the trench at the rate of one part compost to two parts topsoil. Plants to be planted at 3 per linear metre in a single row. All stock shall be planted to the root collar and well firmed in place.

On completion all hedge plants shall be thoroughly watered in. After planting a 50mm layer of approved compost fine bark (nominal size 1-10mm) shall be spread over the whole hedge length (600mm wide).

Ornamental shrubs and groundcover areas

Within the plots, plants are to be planted in variety groups of 3-5 plants per group, with taller species to back of beds and lower growing species to the fronts and adjacent to pathways. Within open space areas, plants are to be planted in variety groups of 5-7 plants per group, with taller species to the centre of beds and lower growing species to the edges and adjacent to pathways.

All shrub beds shall be back-filled with good quality topsoil depth 450mm, the base ground being thoroughly broken up before placement. Tree and shrub planting compost shall be spread to a minimum depth of 50mm and thoroughly rotavated in during cultivation. All stock shall comply with the specification provided on the drawing. All plants shall be well firmed in after planting and watered. After planting all beds shall receive a 50mm layer of approved forest bark mulch over the extent of the bed.

Turf (Front gardens of plots)

All areas to be turfed shall be top-soiled to a minimum depth of 150mm, the base for which shall be thoroughly broken up. Once placed, the topsoil shall be cultivated and fine graded to even running falls before raking and cross raking. Prior to laying, a pre-seeding fertiliser shall be applied in accordance with the manufacturer's instructions. Turf (such as Rowlawn Medallion or similar approved), shall be laid to front garden areas in accordance with good practice.

Grass Seed Rear gardens of plots All areas shall be seeded with Emorsgate EG22 Strong Lawn Mix, or similar approved. All areas to be newly grass seeded, shall be too-soiled to a minimum depth of 150mm the base for which shall be thoroughly broken up. Once placed, the topsoil shall be cultivated and fine graded to even running falls before raking and cross

All grass seed is to be sown, preferably in autumn or spring but it can be sown at other times of the year if there is sufficient warmth and moisture. The seed must be surface sown, applied by a small machine or broadcast by hand. For even distribution, divide the seed into two or more parts and sow in overlapping sections. Firm in the seed with a roll, or by treading to give good soil/seed contact. Do not incorporate the seed into the soil or cover

Amenity Grass Areas

Arreas of open space identified on the plan shall be mown regularly (to maintain at approximately 25mm high. Collect and remove all arisings.

Meadow areas within open space - (around attenuation basin)

Meadow areas as identified on the plan shall be mown regularly throughout the first year of establishment to maintain the balance between faster growing grasses and slower developing wild flowers, and to remove competition from the first flush of annual weeds. From the second year of establishment onwards areas should be allowed to grow to full height and be cut once a year at the end of August or grazzed All arisings are to be allowed to lay in situ for ten days to allow seeds to be cast within the area prior to removal from site or

Bulbs Bulbs shall be allowed to die back within grass areas for a period of six weeks following flowering. Following this, mowing of these areas can be carried out (if applicable).

- All stock is to be rootballed/container grown unless planted during planting season.
- · All shelters and tree wrapping to be biodegradable;
- No cultivation should be undertaken in wet/waterloaged conditions:
- Imported topsoil to accord with BS3882:
- · Supplying nurseries shall be registered under the HTA Nursery Certification Scheme, and plant material should be of certified British provenance
- · All plants shall be packed and transported in accordance with the Code of Practice for plant handling as Published by The Committee for Plant Supply and Establishment (CPSE):
- · All plant material to conform with BS:3936 and BS:4428;
- Planting operations to be undertaken during appropriate climatic conditions to avoid
- wet/waterlogged or frost bound soil conditions, frosts, droughts or during periods of excessive cold drying winds.
- · Landscape contractors to confirm potential build programme with house builder when pricing soft landscape works to allow for and accommodate potential out of season planting and phased release of plots for implementation. Allowances to potentially include for supply of containerised stock, additional attendance in relation to phasing and additional watering.



Programme

- All bare root planting to be undertaken during the planting season November March. (All ground cultivations to be undertaken under suitable conditions).
- Shrub and tree planting within housing areas to be implemented in phases as sections of building works are completed. (Container and root-balled stock is specified for this purpose). Close attention to be paid to watering of plant material outside the planting season as set out in the specification.
- Seeding works and cultivation to be undertaken in the late summer to mid-autumn
- · Any replacement planting required during the initial maintenance period is to be undertaken during the planting season, (November to March).

NOTES:

Planting and lawns in private areas will be maintained as detailed below until occupied. Once occupied, the planting and lawns in private areas shall be maintained by the individual plot holders. All planting in open space areas shall be maintained as detailed below by the management company in good order with any plant material which dies within a five year period being replaced to the original specification.

All trees shall be regularly checked and any broken ties, guards or stakes replaced. Mulch shall be topped up to maintain original levels. In periods of dry weather all trees during years 1-5 shall be regularly watered to field capacity. The area around the base of each tree is to be kept mulched to 50mm depth minimum and weed free to a minimum diameter of 1m during years 1-5. At the end of each growing season for years 1-5 all trees shall receive an application of slow release fertiliser. After approximately 5 years stakes and ties are to be removed once trees have established.

Hedgerows

All hedgerows shall be maintained weed and rubbish free and any loose plants re-firmed. All plant protection measures where employed shall be regularly checked and adjusted or replaced as required. All hedge lines shall be regularly watered in times of drought to field capacity during years 1-5 and shall receive an application of slow release fertiliser at the end of the growing season for years 1-5. Mulch shall be regularly topped up to original levels during years 1-5 Cutting hedgerows is to be undertaken outside the bird breeding season (March to end August). After approximately 5 years stakes and ties are to be removed once trees have established.

Ornamental Shrub Planting Areas

Plant borders are to be kept weed and rubbish free and any loose plants re-firmed. All borders to be regularly watered in times of drought during years 1-5 and receive an annual application of slow release fertiliser for years 1-5. Mulch shall be topped up annually to original levels during years 1-5.

Grass areas (front lawn of properties)

Any turfed areas which fail to provide a good quality initially vigorous grass sward shall be re-cultivated and resown / re-turfed as required during the first season

Planting Schedule

LOW SHRUBS/ PERENNIALS

	Plant Species	Size	Spacing (/m2)
C.a.I	Cornus alba 'Ivory Halo'	2L 30/40cm	5
CcFC	Carex comans 'Frosted Curls'	2L 20/30cm	5
C.L	Crocosmia "Lucifer"	8/10cm Bulb	5
Ct	Choisya ternata	10L 30/40cm	5
EfSQ	Euonymous fortunei 'Silver Queen'	1.5L 30/40cm	4
EfES	Euonymous fortunei 'Emerald Surprise'	1.5L 30/40cm	4
HAG	Hebe 'Autumn Glory'	2L 20/30cm	5
HaRE	Hebe 'Red Edge'	2L 20/30cm	5 5 5
HMB	Hebe 'Midsummer Beauty'	2L 20/30cm	5
HMW	Hebe 'Mrs Winder'	2L 20/30cm	5
LaH	Lavandula 'Hidcote'	3L 30/40cm	4
P.b.S	Persicariabistorta 'Superba'	1L 20/30cm	5
Pf	Potentilla fruticosa 'Abbotswood'	2L 20/30cm	4
Vm	Vinca minor	1.5L 5-10cm	5

FENCESIDE MIX

- 1	Plant Species	Size	%	Spacing (/m2)
BIAN	Berberis thunbergii 'Atropurpurea'	3L 30/40cm	30	4
CsPL	Chaenomeles x superba 'Pink Lady'	2L 40/60cm	10	4
LaH	Lavendula 'Hidcote'	3L 30/40cm	40	4
Ln	Lonicera nitida	2L 40/60cm	20	4

PROPOSED TREES

	Plant Species	Size (girth cm)
Aca A.c.E Bp Pav P.U. Sa	Acer campestre Acer campestre 'Eisrijk' Betula Pendula Prunus avium 'Plena' Prunus avium 'Umineko' Sorbus aucuparia	HStd BR 12-14cm HStd BR 12-14cm HStd BR 12-14cm HStd BR 12-14cm HStd BR 12-14cm EHStd BR 14-16cm

HEDGEROW

	Plant Species	Size	
FS	Fegus Sylvatica	B 40-60cm ht	5/linear meter (in a double staggered row)
Prr	Photinia Red Robin	C 5L 60/90cm ht	3/linear meter (in a double staggered row)

NATIVE BUFFER MIX

	Plant Species	Size (girth cm)	Groupings	%
	Acer campestre	B 1+1 60-80cm	groups 3-8	10
	Crataegus monogyna	B 1+1 60-80cm	groups 3-8	25
	Cornus sanguinea	B 1+1 40-60cm	groups 3-8	5
	Corylus avellana	B 1+1 40-60cm	groups 3-8	25
	Euonymus europaeus	B 1+1 40-60cm	groups 3-8	5
	Lonicera periclymenum	C 1L	Individuals	5
	llex aquifolium	C 1L	Scattered individuals	5
	Malus sylvestris	B 1+1 60-80cm	groups 3-8	5
	Prunus spinoa	B 1+1 60-80cm	groups 5-9	5
	Rosa canina	B 1+1 60-80cm	groups 3-8	5
	Viburnum opulus	B 1+1 40-60cm	groups 3-8	5
MEADOW	V GRASS			
	Meadow Type	Seed Mix		Distribution Rate (g/m2

Emosgate EM8 (or similar approved)

A.	Existing tree indicated on site n/o 48 St Margaret's	25.10.22
Revision	Notes	Date





PROPOSED RESIDENTIAL DEVELOPMENT, ST MARGARET'S, QUADRING, SPALDING, LINCS.


LANDSCAPING PLAN


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SMO-SH-SL-AR-04 A



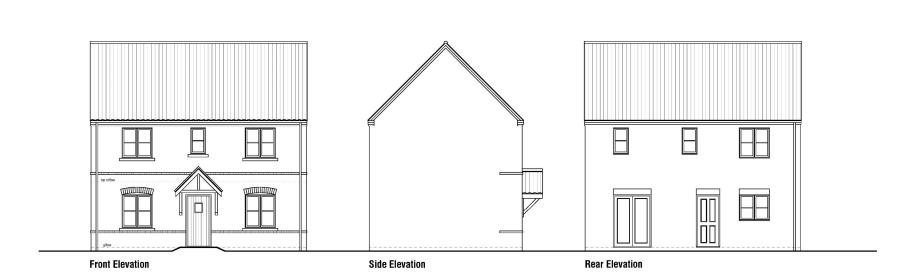

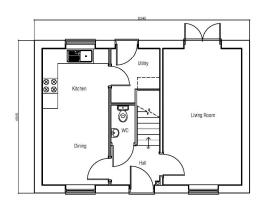

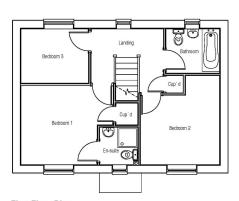

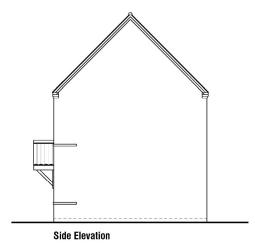First Floor Plan

House Type - Alnwick


Ground Floor Plan


Floor Plans & Elevations

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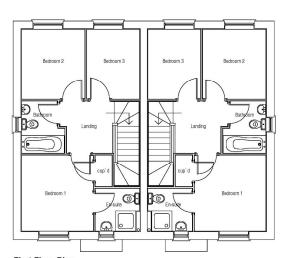







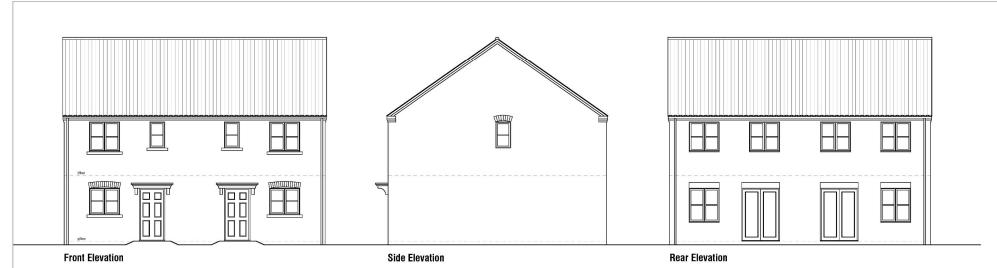

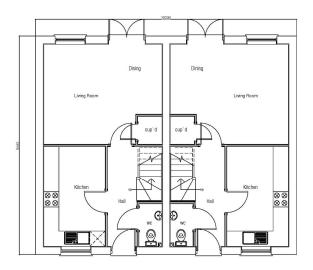Ground Floor Plan



First Floor Plan

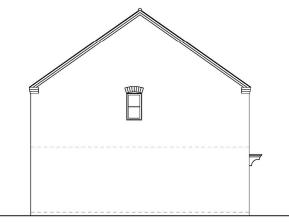

Side Elevation

House Type - Hylton

Floor Plans & Elevations

1 (5) (6)

HT Hylton - 01 - Plans & Elevations 1:100 @A3 July 2021 MD


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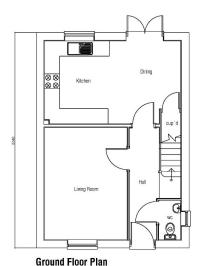
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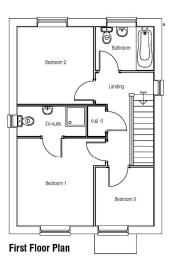
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House Type - Ludlow

Floor Plans & Elevations

HT Ludlow - 01 - Plans & Elevations 1:100 @A3 July 2021 MD

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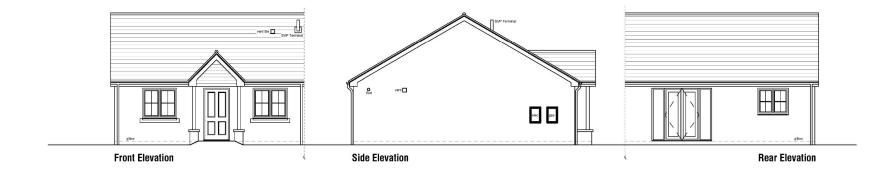
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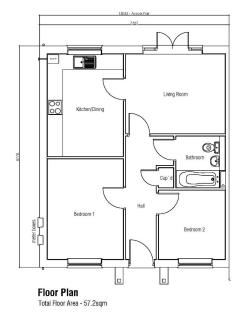
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NOTES:



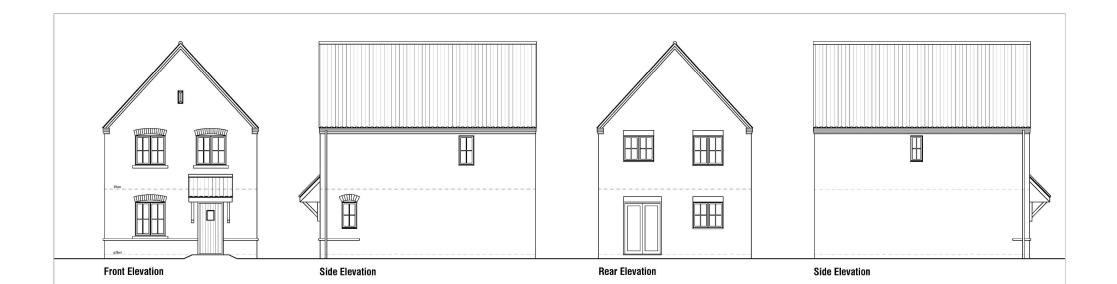

House Type 11


Floor Plans & Elevations

1:100 @A3 July 2021 MD

HT11 - 01 - Plans & Elevations





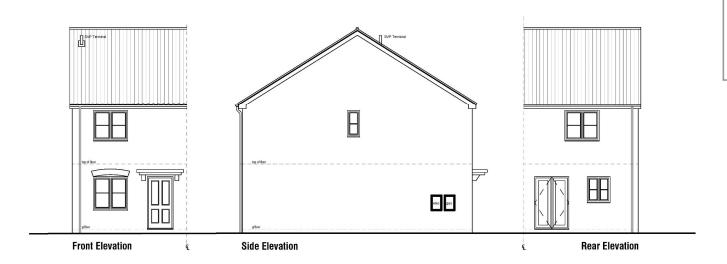

Kitchen/Dining DO WC



House Type 13


Floor Plans & Elevations

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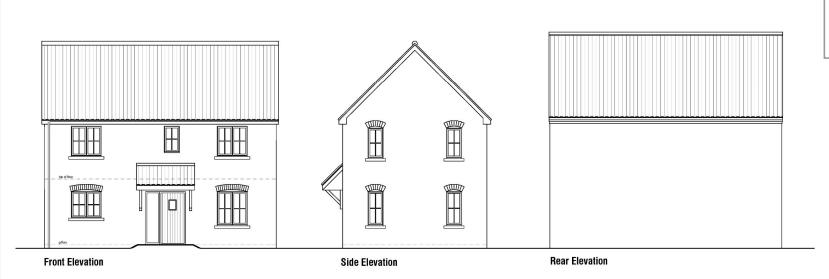
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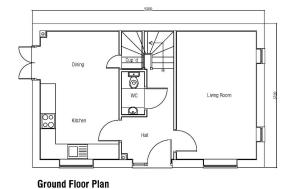



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IF IN DOUBT ASK I





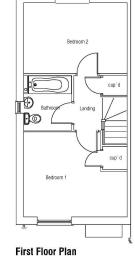

Rear Elevation

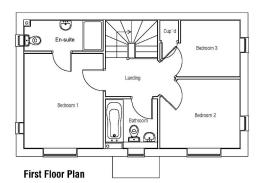House Type 19

Floor Plans & Elevations

Front Elevation Side Elevation Rear Elevation

Living Room Cup'd WC Kitchen/Dining



Bedroom 1 Bedroom 3 Cup'd Bedroom 4

First Floor Plan

House Type 27

Floor Plans & Elevations

HT 27 - 01 - Plans & Elevations

NOTES:


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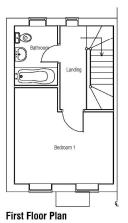
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Cup'd Cup'd Cup'd Ground Floor Plan



House Type 53

Floor Plans & Elevations

HT53 - 01 - Plans & Elevations

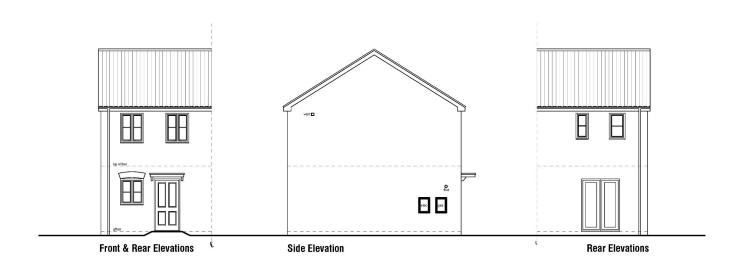1:100 @A3 July 2021 MD


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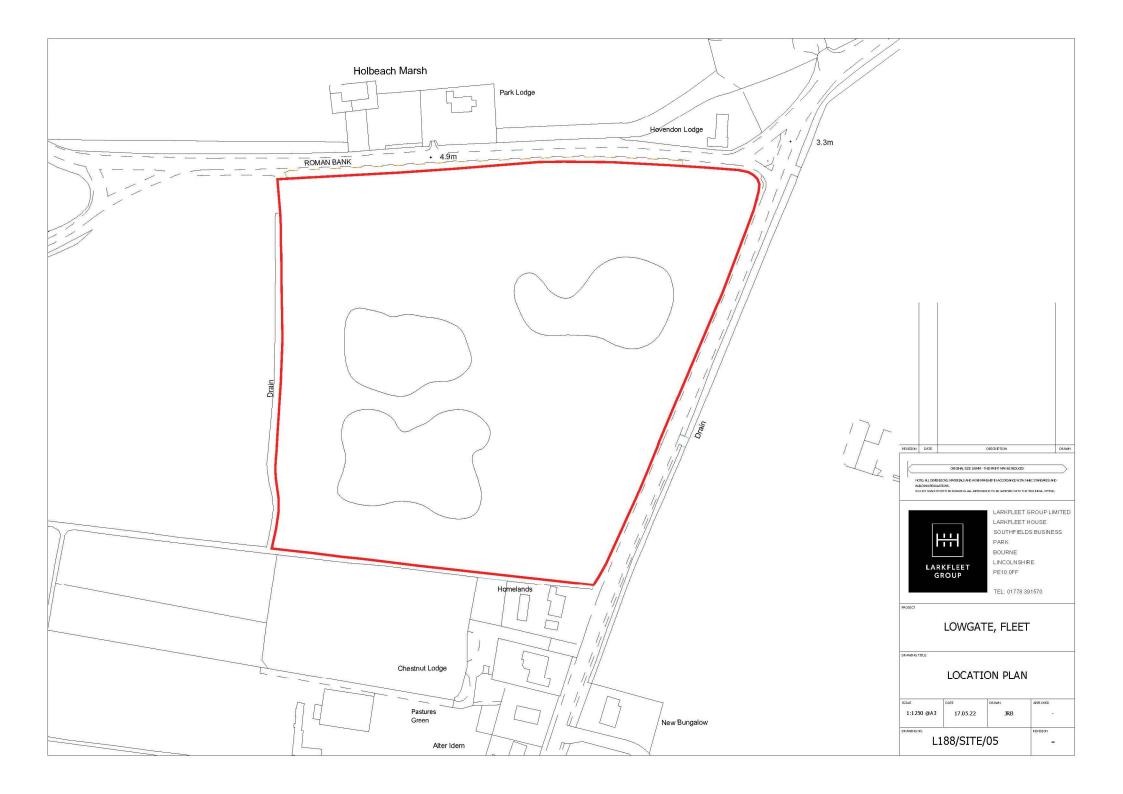









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PROPOSED BUILDING LINE

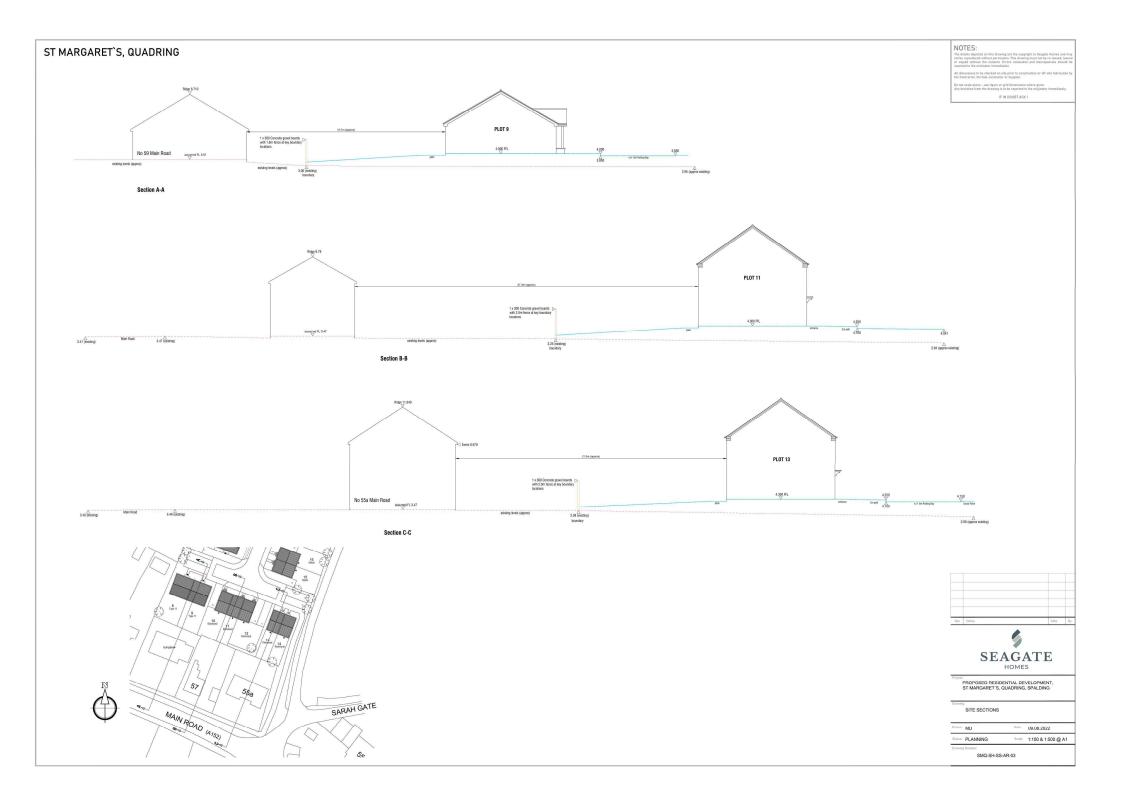

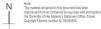REE
reglanted
from within
suchere new
f)



PROPOSED TRE
To be selected from the
following:
Acer campestre
Alder glutinosa
Betula pendula
Saltr pinerea





HEDGEROW WITH TREE PLANTING To be selected from the following: Cratagus monogyna (10%) Nex Aquitalum (30%) Prunus spinosa (10%) Taxus baccata (20%)

Sizes to be selected from

9 29 09:22 Southern bund trees reinstated DC 8 28:09, 2022 Notes added to plan DC 7 27:09, 2022 Notes removed from plan DC 5 26:09, 2022 Hedge species list updated & Storage added 5 08:09, 2022 Hedge species list updated &

Gloucester House, 399 Silbury Boulevard Milton Keynes, Buckinghamshire MK9 2AH T 01908 303701



client	
Larkfleet Group	
project	scale
Laurente	1:500 @ A
Lowgate	date
Fleet	May 2022
title	drawn
	DC
General Arrangement	checked
-	RH
drawing number	revision
05-1071-301	P09









North Elevation

West Elevation


South Elevation





East Elevation





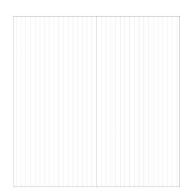

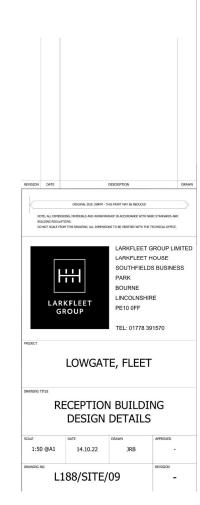

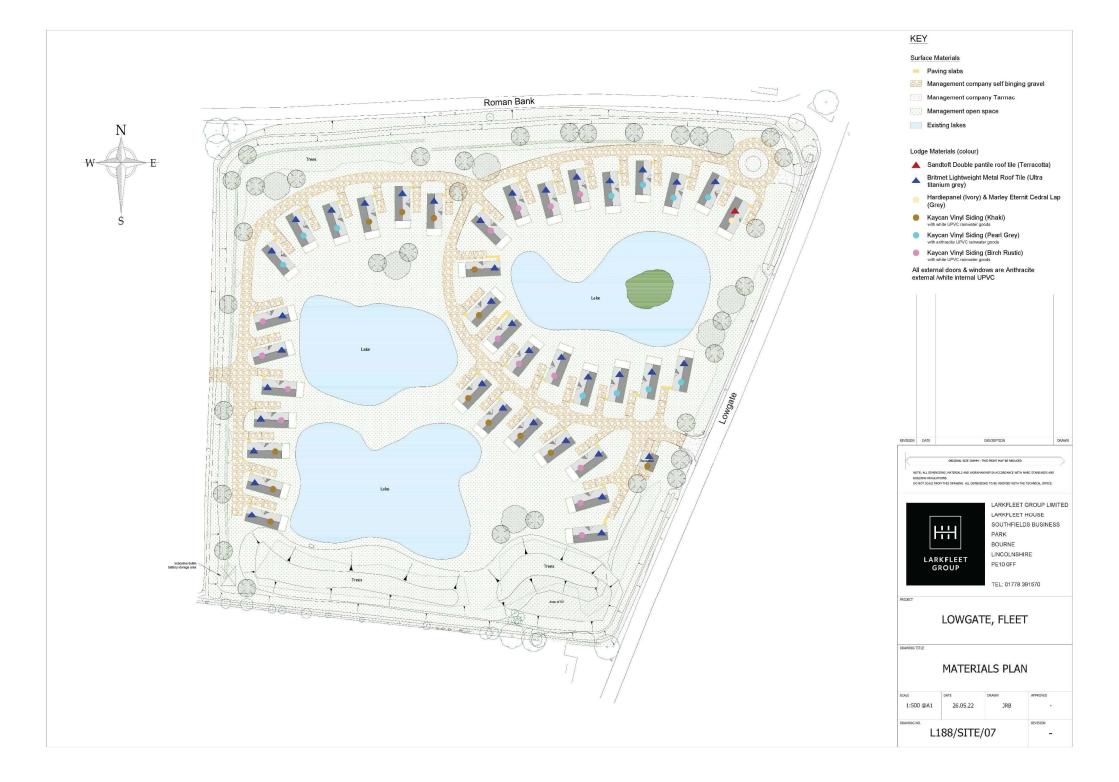



























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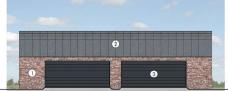




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North Elevation 1:100




West Elevation 1:100



South Elevation 1:100



East Elevation 1:100

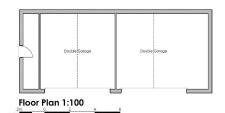

MATERIALS KEY

Red Multi Facing brickwork
 Mid Gray pre weathered Zinc Standing Seam Cladding
 Anthracite Aluminum Windows and Doors



519.PL.03

New Linear Solid drainages feature

Existing Paddock retained

At disceptional size to be supply to the other for of the tellow of fine. The corporated to this decrease is a second of the other one. Service of the servic being hedge retared Gravel Courlyard -1.2m post and ref.
fence with field gate
to LCC, skyl ways acquire mark DRAW DYKE Marrameter, A PERSON NO HOSPITANT Mr & Mrs Peace CIENT MY & MAY PROCE

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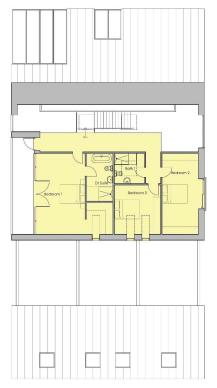
South Elevation

North Elevation











First Floor Plan

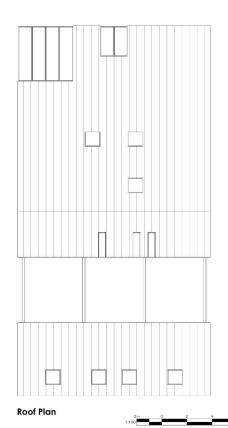

All discrepancies are to be brought to the attention of the below office. The copyright to this drawing is owned by studio 11 architecture.

MATERIALS KEY

- Red Mulli Facing brickwork
 Nid Gray pre weathered Zinc Standing Seam
 Cladding
 Anthracite Aluminum Windows and Doors
 Larch timber cladding
 Laminated Glass Balcony

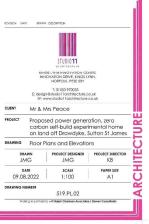










View from Entrance on Draw Dyke

July 202



View from northern drain looking South-East

July 2021

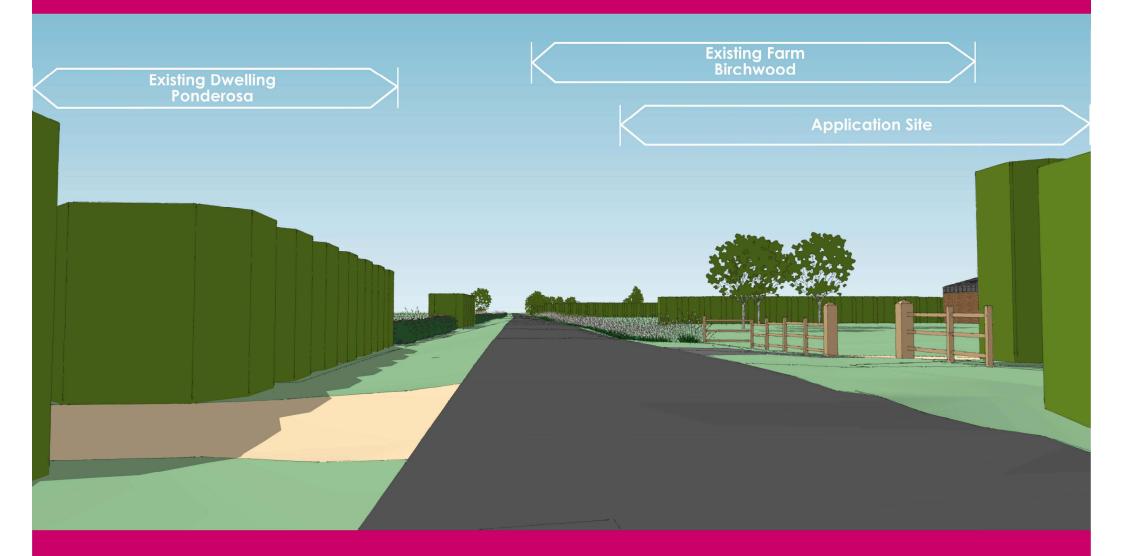

Existing Farm The Oak Grove

Existing
Dwelling
Ponderose

Existing Farm Birchwood

Application Site













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Scale 1:	1250			
Om	25m	50m	75m	100m

LOCATION PLAN 1:1250

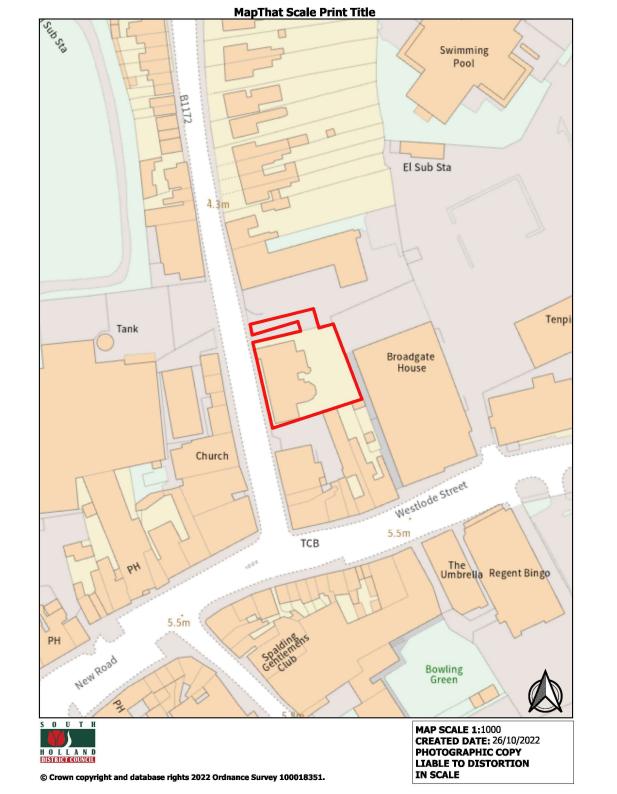

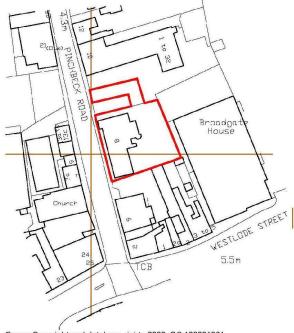

DRAV	wing issue
FEASIBILITY	
PLANNING	
BUILDING REGULATIONS	
CONSTRUCTION	

GOOD-DESIGN-ING Ltd



11 SARACEN WAY, NEWARK ROAD, PETERBOROUGH. PE1 5WS

TEL 01733 569731 E-MAIL robert@good-design-ing.co.uk

DRAWING

Location Plan

PROJECT

Proposed Development at The Grange 8 Pinchbeck Road


Spalding


Scale 1:1250 @ A3 size


June 2022

drawing number: 221288-05



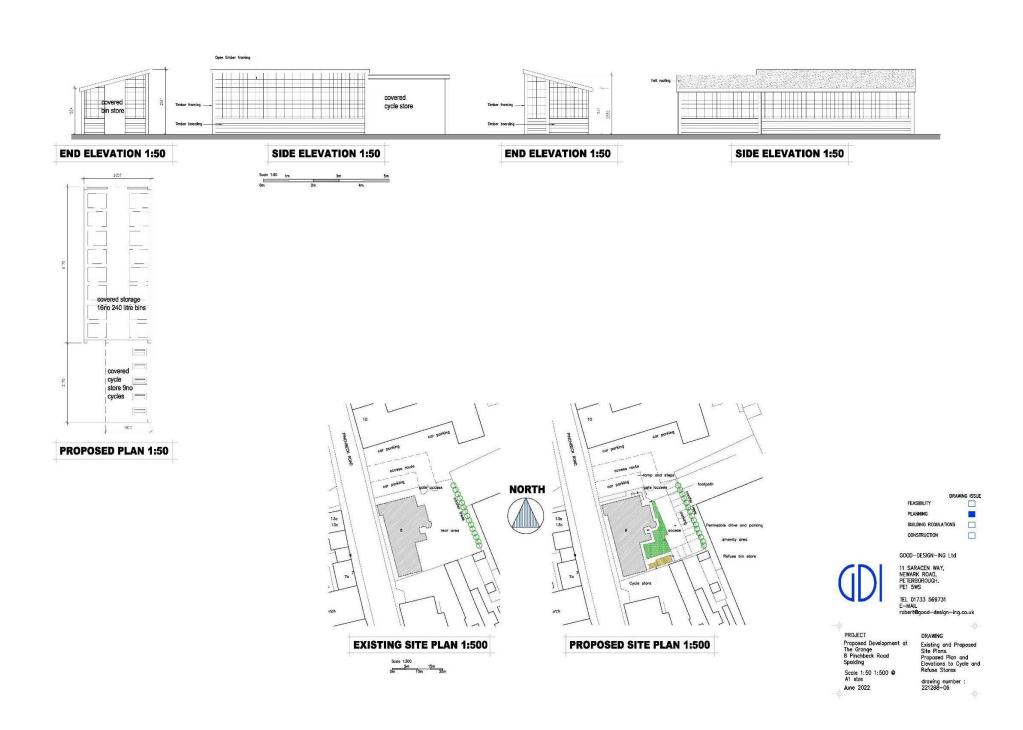

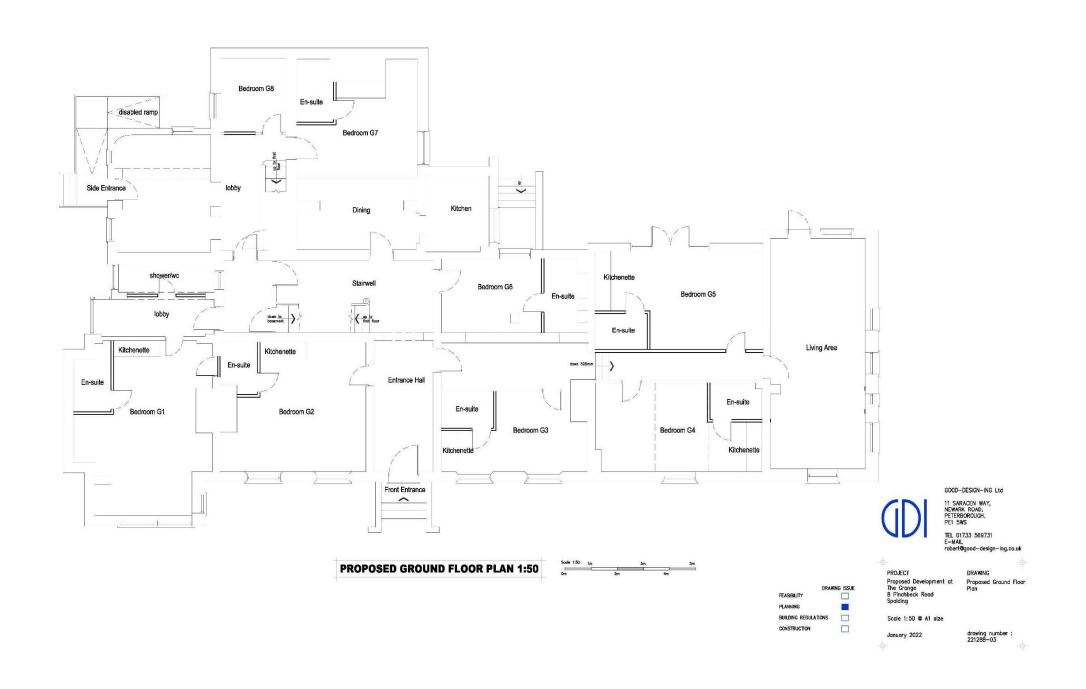

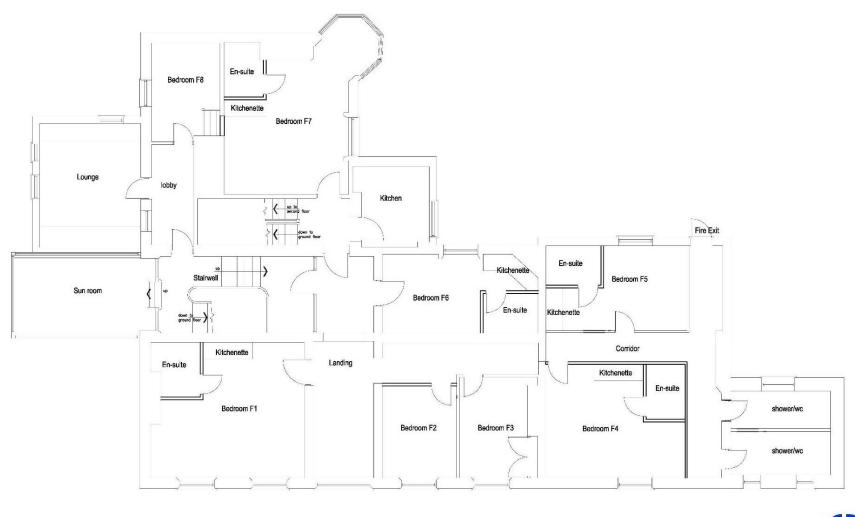

PROPOSED FIRST FLOOR PLAN 1:50



PROJECT

GOOD-DESIGN-ING Ltd

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DRAWNG

Proposed First Floor Plan


DRAWING ISSUE FEASIBILITY BUILDING REGULATIONS CONSTRUCTION

Scale 1:50 @ A1 size

Proposed Development at The Grange 8 Pinchbeck Road Spalding

January 2022


drawing number : 221288-04

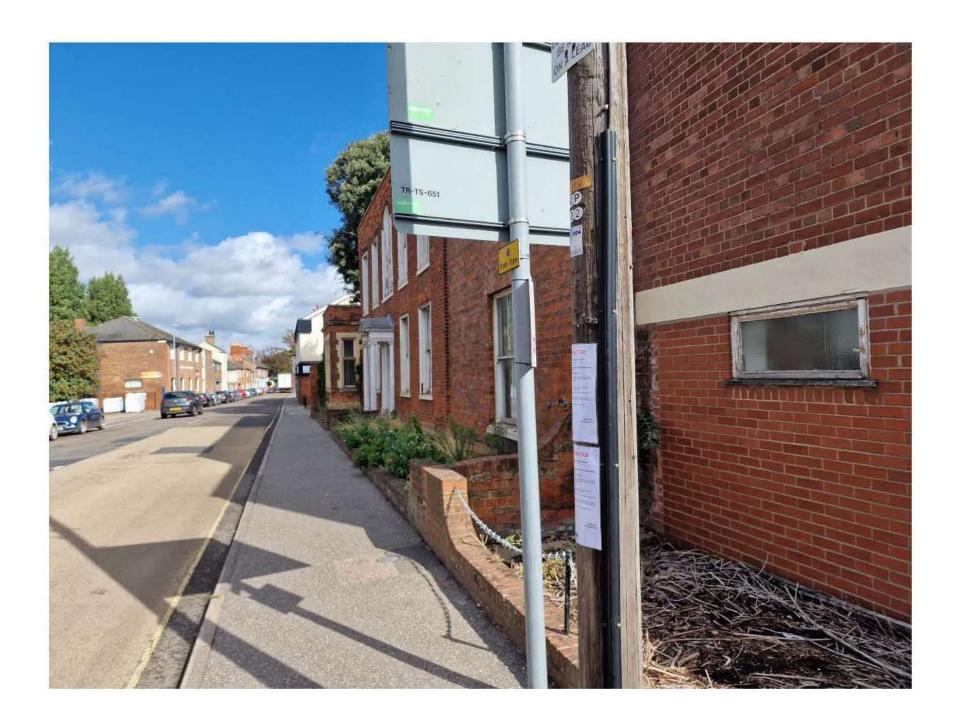








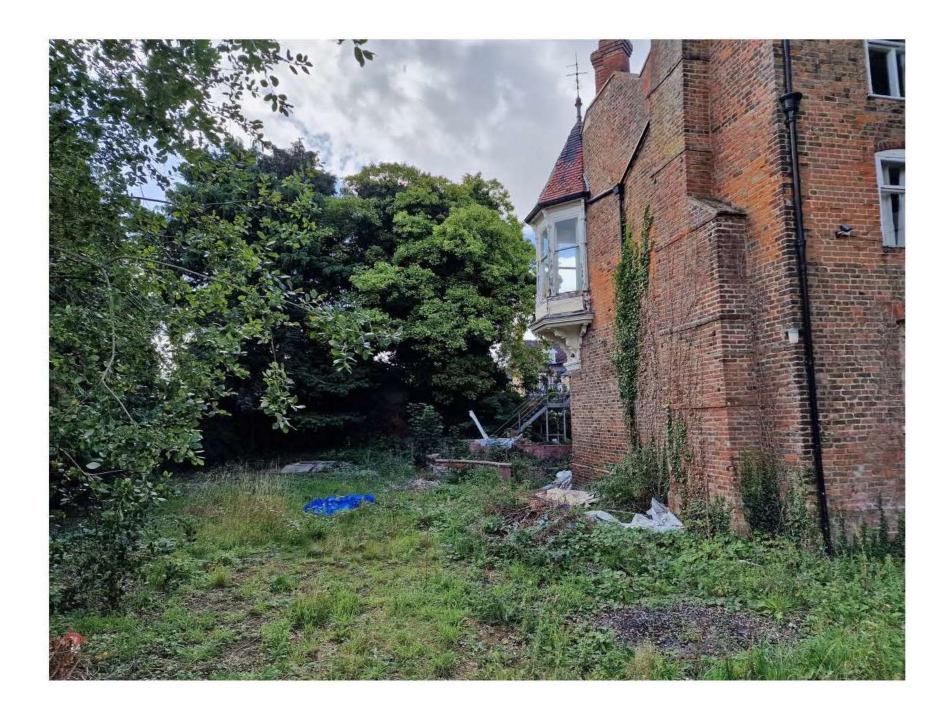



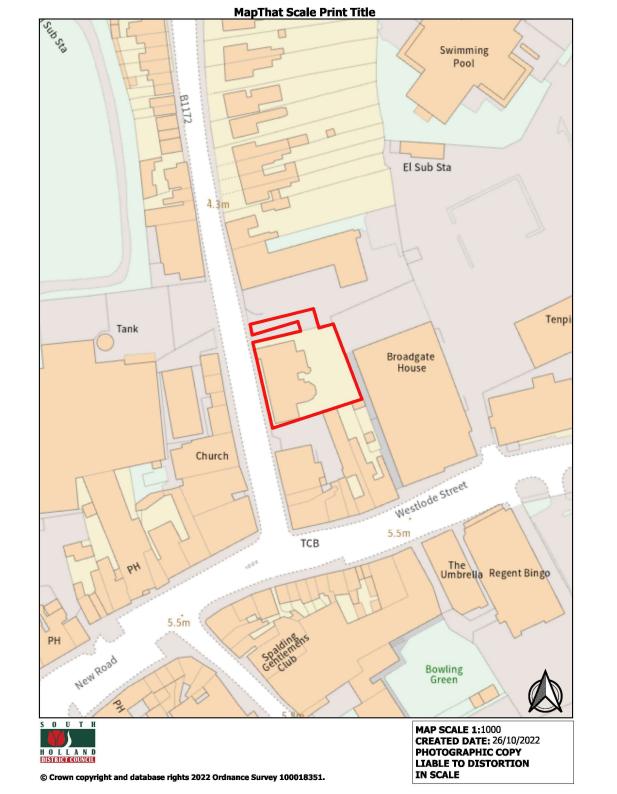








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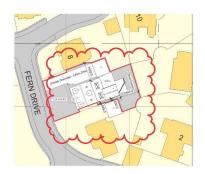


Om 25m 50m 75m 100m 125m







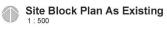



0m 10m 20m 30m 46m 50m





Existing North East Elevation (Rear)

1 100 2m	4m	6m	8m	10m
-		_	_	



Existing North West Elevation (Side)

1:10	00				
Om	2m	4m	6m	8m	10r
1000				_	- 1
THEFTALLS					



Existing South West Elevation (Front)


Om	2m	4m	6m	8m	
THE		_			



Existing South East Elevation (Side)

1:100	,				
0m	2m	4m	6m	8m	1
SHEE				_	



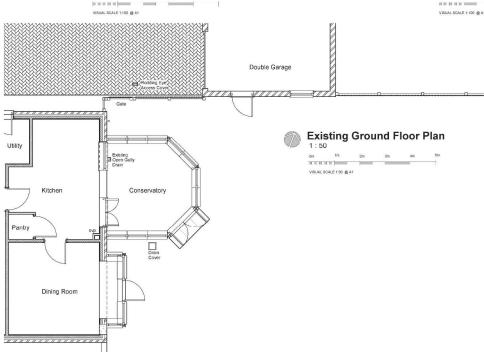














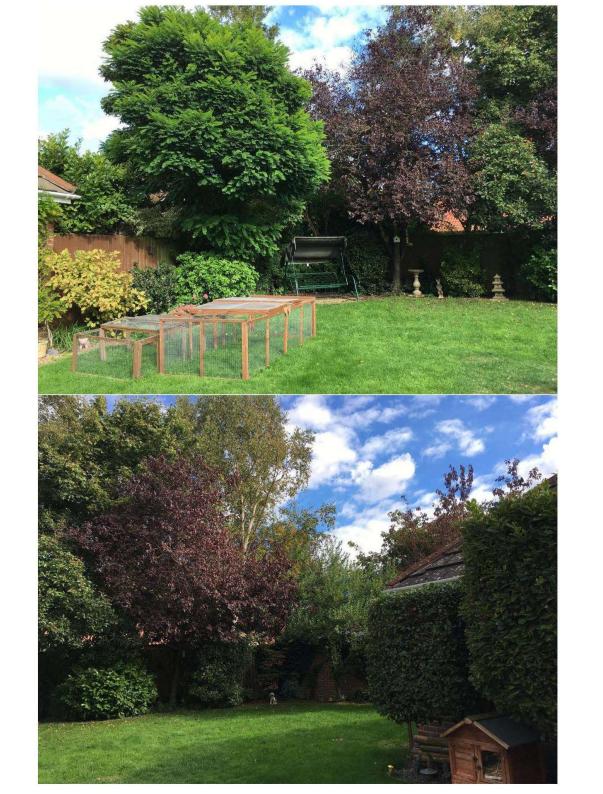











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