

Welcome to the Planning Committee



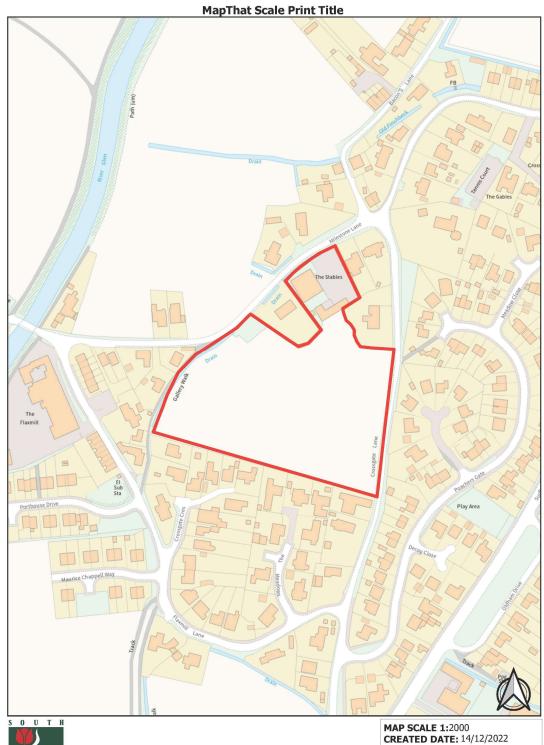


MAP SCALE 1:2000 CREATED DATE: 14/12/2022 PHOTOGRAPHIC COPY LIABLE TO DISTORTION IN SCALE



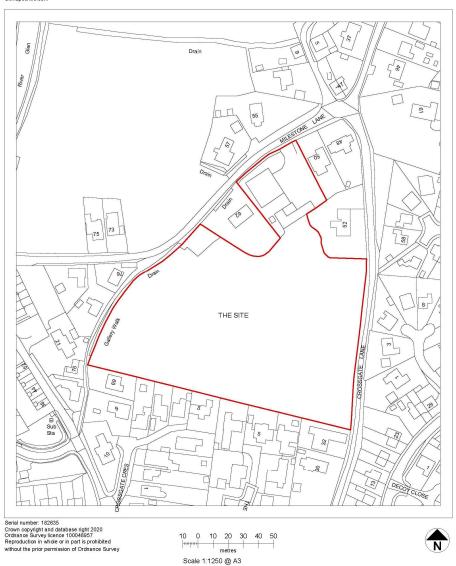

OCrown copyright and database right 2020 Ordenance Survey Utence 100048957 Reproduction in whole or in part is prohibited without the propo pentisdan of Demonsor Survey

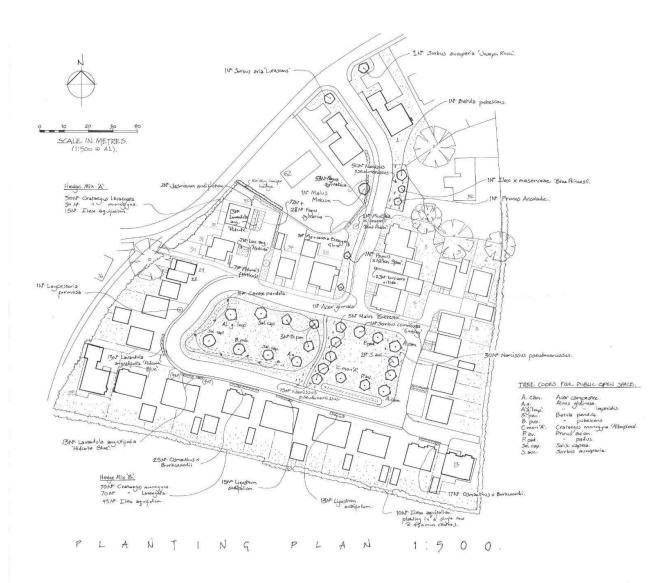

EXISTING TREE TO BE RETAINED.

EXISTING HEDGEROW TO BE RETAINED.

NEW SPECIMEN TREE.

NEW HEDGE.

NEW CLIMBER.

O NEW SPECIMEN SHAUB.

GRASS SEEDING/LAWN.

SPRING BULGS.

N.B. This planting plan has been prepared to satisfy conditions 3(w), 5, 6, 7 & 8 (part) of the planning consent for the development of the site for residential (H14-1311-16). It should be read in conjunction with the Post-Planting Maintenance document and the Planting Schedule.

This scheme has been prepared without the benefit of information or drawings showing the location of all underground services & easements. It is therefore the responsibility of the main contractor identify these prior to landscape operations on site.

Please do not scale from this drawing.

- RENISION A ~ 29th Sept 22. Amended site layout inc (Plots 1, 3-6, 13, 24, 28, 27-35) \$ additional planting.

JONATHAN BIGGADIKE PG Dip LA CMLI

CHARTERED LANDSCAPE ARCHITECT

eject: Planting masterplan for residential development.

nt: Postland Developments Limited.


Location: Milestone Lane, Pinchbeck, Lincolnshire, PE11 3XR.

Drawing No: MLP/22/01.A. Date: May '22.


M: 07772 509351

E: jbiggadike@outlook.com

Trading as Dragonfly Building Conservation & Landscape Design Ltd.

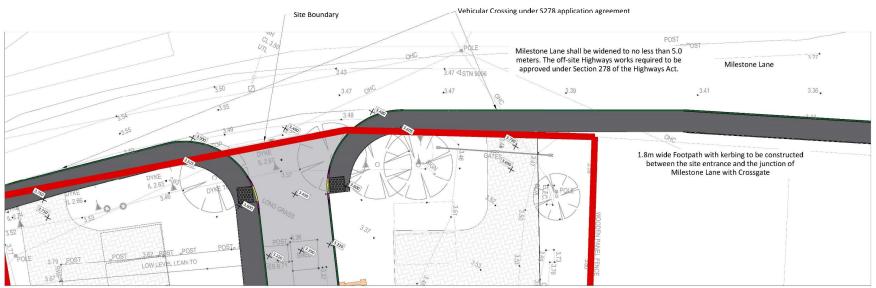

Footpath and Milestone Lane Plan Scale (1:100)

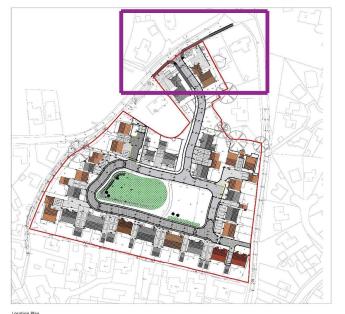

Location Plan Scale (1:1000)

NOTES

1. Do not scale this drawing.

2. All dimensions are in millimetres unless stated otherwise.

This drawing to be read in conjunction with all other relevant drawings and specifications.

All proprietary items to be installed in strict compliance with manufacturers instructions and recommendations.





P6	Amended Plans	PSP	13-09-2
P5	Re-Design	AJP	22-04-2


Postland Management Ltd

The Burells Milestone Lane Pinchbeck

Off Site Works General Arrangement

Job No	21027			
Drawing N	°21027-01	.3		P6
Status	Prelimina	iry		Rev
Scale	As Stated	Date	08-11	-21
Project		Drawn B	y	AJP
Engineer	TBP	Checked	By	TBP
		Approve	1 BV	



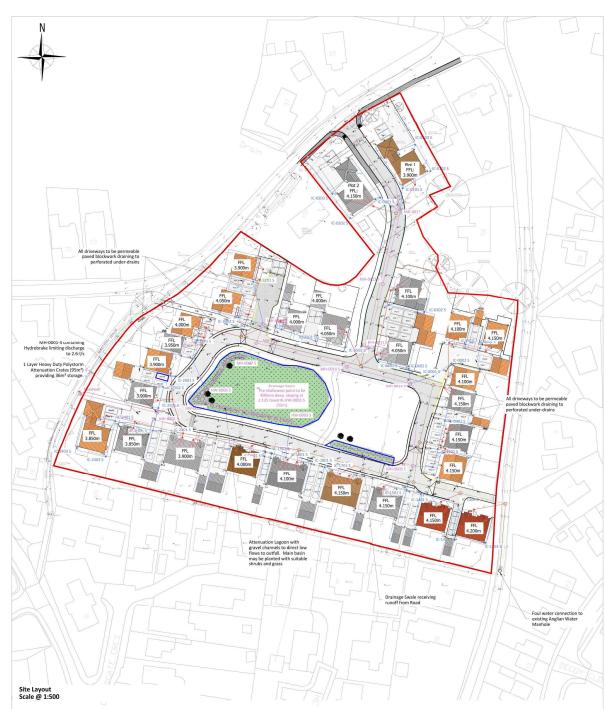

Project Details

The site is located off Milestone Lane, Pinchbeck, Spalding. The postcode for the site is PE11 3XR and the approximate centre of the site at National Grid Reference TF 24240 26600.

The site size is more than a hectare (1.88 ha). The site is currently greenfield disused soft landscaping. The proposed development includes proposals for the construction of 35 dwellings with roads, driveways and parking spaces as follows:

•• Housing (Roofs) : 3327m²
•• Driveways and Parking : 2608m²
•• Adoptable Road and Footpath: 1970m²

Total Impermeable area: 7905m² (Approx 42% of the Site)

Superficial deposits are silty fine Sands. Infiltration tests have shown an infiltration rate of $3.67 \times 10e-6$ m/s. and ground water was encountered 0.95m below existing ground level.

Drainage and SUDS Strategy:

As stated in CIRIA SuDS Manual 2015 the objective of sustainable drainage systems is to maximize the benefits and minimize the negative impacts of surface water runoff from developed areas. By applying SuDS methodology, storm runoff from the Site is controlled to ensure that flow rates in downstream watercourses are not increased and the water is appropriately treated to remove any contaminants, thus ensuring the quality of the water in the natural environment downstream.

Drainage Hierarchy:

	Drainage Hierarchy	Y/N	Comment
1	Infiltration to maximum extent	N	Due to high water table, soakaways are not suitable
2	Discharge to Surface Waters	Υ	An existing Surface Water ditch will be utilised to the western side of the site
3	Discharge to Surface Water Sewer	N	None available
4	Discharge to Combined Sewer	N	Only option remaining

Key aspects proposed:

- It is proposed to provide an adoptable drainage system throughout the development, receiving runoff from
 roofs, driveways and the access road. These flows will be attenuated before discharging into the existing
 surface water ditch running along the western side of the site.
- Runoff from private driveways and parking spaces will be filtered through a filter media within permeable surfacing.
- The Adoptable Road shall be drained either through the collection of water using gullies and discharging through a gravity operated system or using a grass filter strip to a Swale, both to be adopted by Highways. A perforated underdrain shall be adopted by Anglian Water.
- Discharge from the Site shall be restricted to Greenfield Runoff Rate of 2.6-l/s (As stated on HR Wallingford)
 using a Hydrobrake in MH-0001-S
- Attenuated water shall be stored in a combination of the Swales/Lagoon and the underground attenuation crates & subbase for all storm events upto 1 in 100-year + 40% Climate Change event.
- All flooding will be routed away from the properties and collected in a vegetated area in the centre of the site.

Storm Water Attenuation

Attenuation Volume Provided shall be 667.6m³, (Subbase = 130.3m³; Swales = 537.3m³)

- Attenuation Volume used in 1 in 30 yrs storm event: 32%
 Attenuation Volume used in 1 in 100 yrs storm event: 46%
- Attenuation Volume used in 1 in 100 yrs storm event: 46%
 Attenuation Volume used in 1 in 100 yrs storm event + 40% Climate Change: 73%

Foul Water

An adoptable foul water system shall be provided discharging to an existing public sewer in the south eastern
point of the site.

xceedence Flows

Storm Water System is designed to receive and contain within the site boundary all rainfall up to & including 1:100 AEP. Larger flows are expected to follow the topography of the site and discharge on to the vegetated area within the centre of the site. Exceedence Flows is exceptional events or due to blockage shall be routed away from all

Management & Maintenance:

The maintenance activities listed below are considered to be the basic tasks necessary to keep the site drainage systems working at optimum efficiency, which is necessary to ensure that they have capacity to deal with extreme / unusual events. Other activities, such as little removal / repairs etc. will also be required.

Area	Maintenance Activity	Frequency	Responsibility	
Foul Drainage	CCTV/Jetting of Sewers	Every 10-Years	Anglian Water	
	Repairs to Sewers	As Required	Anglian Water	
Foul Drainage Hard- Surfacing & Drainage	Blockwork paved areas to be swept and de-weeded Months		Plot Owner	
Hard-Surfacing & Drainage	Cleaning of Gullies	Recommended every 2- Years	Management Company	
Building Roof Drainage Building Foul Drainage	CCTV/Jetting of Sewers	ing of Sewers Recommended Every 10-Years		
Hard-Surfacing & Drainage	Inspection of Manholes/Chambers	Recommended Every 5- Years	Management Company	
Building Roof Drainage Building Foul Drainage	Spillages	Provision of Spill Kits to Contain	Management Company	
	Gutters to be cleared of debris	Recommended Every 2- Years	Management Company	
	Cleaning of below ground pipework	Recommended Every 10-Years	Management Company	
Development Site Access Roads	Periodic sweeping to remove, debris, leaves etc	Every 2-4 weeks during autumn	Highways Authority	
Adoptable Road Drainage	Inspection and Maintenance, Gully cleaning etc.	As Required	Anglian Water	
Soakaway Trenches	ссти	Every 5-Years	Highways Authority	
	Flushing	Every 10-Years	migriways Authority	

UNLESS STATED WITHIN THE CONTRACT THESE DRAWINGS ARE COPYRIGHT AND THE PROPE PARSONS CONSULTING ENGINEERS LTD. COPYING OF THE DESIGNS, DRAWINGS OR INTELLES PROPERTY IN FULL OR IN PARTY IN DIT PERMITTED.

NOTES

1. Do not scale this drawing.

2. All dimensions are in millimetres unless stated otherwise.

3. This drawing to be read in conjunction with all other relevant drawings and specifications.

4. All proprietary items to be installed in strict compliance

Key

HB-HALF BATTERED KERB
BN-BULLNOSE KERB
TN-TRANSITION KERB

Permeable

Tarmac

CONSTRUCTION DESIGN AND
MANAGEMENT REGULATIONS 2015
THE CONTINCIDES ATTENDED IS DRAWN TO THE
MANISCHEM PROPERTY BELLIAN MEMORY
AND ADDRESS OF THE MANISCH MEMORY
AND ADDRESS OF

Postland Management Ltd

The Burells Milestone Lane Pinchbeck

Title

Drainage Strategy

| 2007 | | 2007 | | 2




4 Angel House, Eastgate, Whittle Peterborough, PE7 1SE 07961 783825

www.parsonsengineers.co.


NOTES

- 1. Do not scale this drawing.
- 2. All dimensions are in millimetres unless stated otherwise.
- This drawing to be read in conjunction with all other relevant drawings and specifications.
- All proprietary items to be installed in strict compliance with manufacturers instructions and recommendations.

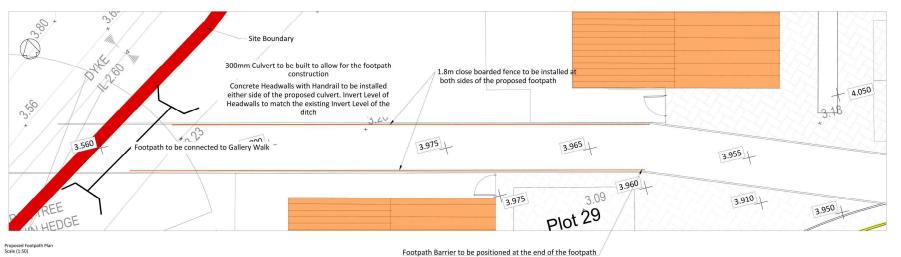

50x150 (EF) Precast concrete edging to BS EN 1340:2003 50x150 (EF) Precast concrete edging to BS EN 1340:2003 25mm of ACB Dense Surface 100/150 bin rec ST3 Concrete to SHW 100mm of AC20 Dense Binder 40/60, 70/100 -100/150 bin rec (Clause 9.1) 100mm of Type 1 Sub-base (Clause 8.1)

Proposed Footpath Construction Detail Scale (1:10)

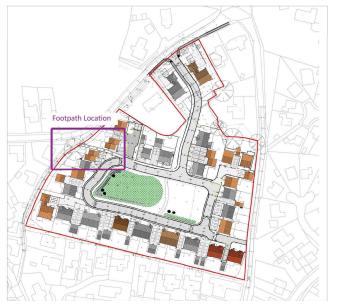

Location Plan Scale (1:1000)

up to the Architect's Specification





Postland Management Ltd


The Burells

Milestone Lane Pinchbeck

Proposed Private Footpath

Job No	21027				
Drawing No	21027-01	.2			Р7
Status	Prelimina	ary		Rev	
Scale	As Stated	Date	08-	11-21	
Project Engineer		Drawn	Ву	AJP	
Engineer	TBP	Checke	d By	TBP	
		Approv	ed By		



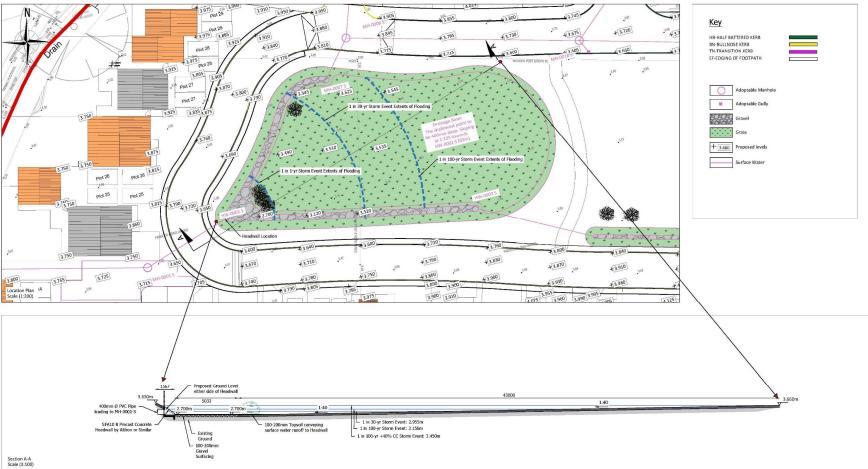

Do not scale this drawing.

2. All dimensions are in millimetres unless stated otherwise.

3. This drawing to be read in conjunction with all other relevant drawings and specifications.

4. All proprietary items to be installed in strict compliance with manufacturers instructions and recommendations.

STANDARD DRAINAGE NOTES:

- Except where specifically shown otherwise all below ground pipes / connections shall be 100mm dia PVC (b BS 4660) or VC (b BS 5431) with flexible joints and laid to minimum falls of 1 in 40, except where connected to VVC when falls may be 1
- in 80.

 2. All gravly pipe runs to be tested to a standing head of 1500mm head of water above the invert at the head of the pipe run (but not exceeding 400mm at the lower end).

 3. For details of bed and surround requirements refer to long sections and standard details. In all other situations provice 150mm of 10mm single-sized rounded grave bedding.
- and surround.

 4. Except where specifically shown otherwise, pipes to be a minimum of 900mm below roads/driveways and 600mm.
- below gardens/fields.

 5. Ventilating pipes to be provided at the head of each drain and to any branch longer than 6m where a single appliance is connected, or 12m where a group of appliances is connected. 6. Step-irons shall not be fitted in any chambers unless specified
- otherwise.
 7. Manhole/Gully covers shall be regulated to suit finished levels
- and crossfalls

 8. All proprietary items to be installed in strict compliance with
- 8. All proprietary items to be installed in strict compliance with manufactures instructions and necessment actions.
 9. Datins passing betweeth buoldings to have minimum 100mm control in the properties of the strict passing betweeth buoldings to have minimum 100mm of the control in the properties of the state. Just per shall be encessed in concrete integral with the slab.
 10. Claims passing frough welse below ground level to have 10. Claims passing frough welse below ground level to have 10. Claims passing frough well below the state of the properties below the properties of the properties integrated to support well construction above 11. Unless stated for environ, people to 100mm Dameter.
- STANDARD ROADS / FOOTPATH NOTES:
- STANDARD ROADS / FCOTPATE NOTES: I. Existing structures to be broken out to minimum 450mm below top of finished surface level. Existing tootpath to be broken out and rubble and existing subbase to be removed off-site.
- Consistency of the consistency o thickness.

 3. All formations are to be treated with an approved herbicide
- All infinitions are to be dreaded with all approved reactions before placing sib-base material on a geotextile separation membrane (Terram 1000 or similar approved)
 All sub-base material is to be non-frost-susceptible. All concrete to be sulphrate resisting

P2	Section A-A Amended	AJP	16-11-22
P1	Preliminay Isuue	K.P	02-11-22


Postland Management Ltd

The Burells Milestone Lane Pinchbeck

Pond Section Detail

300 110	21027			
Drawing N	°21027-01	L4		P
Status	Prelimina	ary		Rev
Scale	As Stated	Date	02-1	1-22
Project Engineer		Drawn E	by	AJP
Erigineer	TBP	Checked	By	TBP
		Approve	d By	



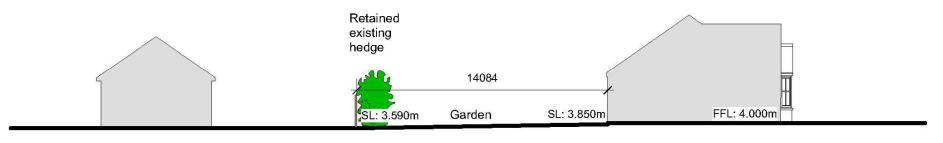

5 Crossgate Crescent

SITE SECTION BB



32 The Meadows

SITE SECTION AA

The Eaton Plot 13


The Eaton Plot 20


Scale 1:200 @ A3


Project THE B PINCH	URRELL BECK	S		Aspect Architectural Design
~	SECTI SECTI			Architectural Designer 29A Church Street Northborough Peter borough Peter 9BN Telephone 07907030047
Scale 1200 @ A4	Date JUN 21	Job No 243		© Copyright
Category D	CiSfb Element	Sequential No 15	Revisions C	

Rev A: April 22 - Site levels added

Rev B: Aug 22 - Plot 13 changed to The Eaton Rev C: April 22 - Dimensions added

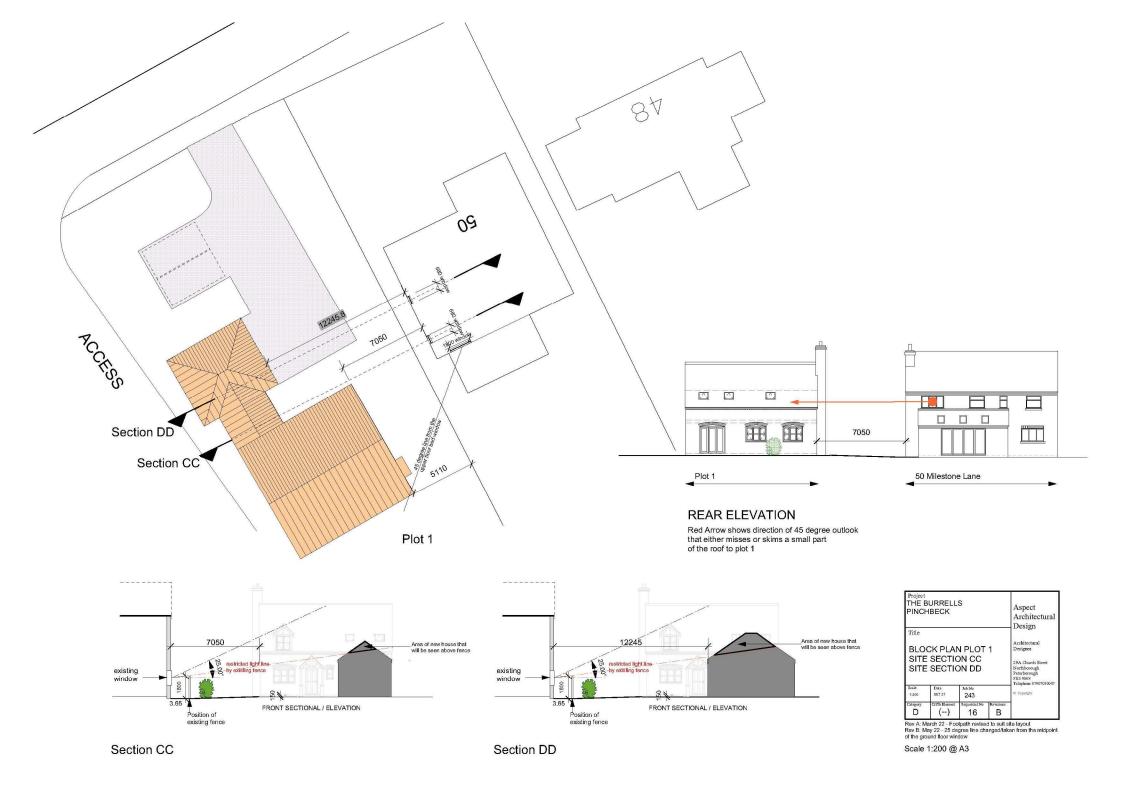

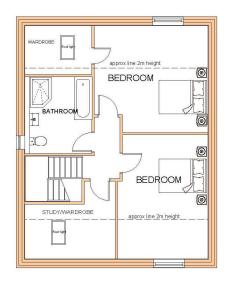


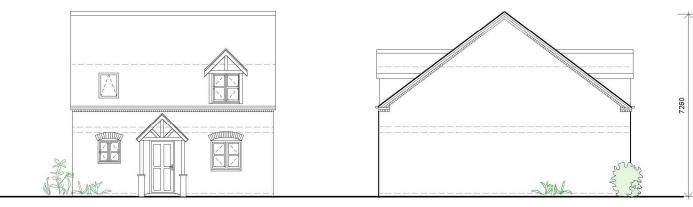

FIRST FLOOR PLAN



FRONT ELEVATION SIDE ELEVATION

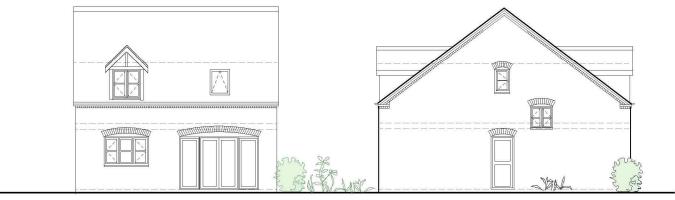

REAR ELEVATION SIDE ELEVATION

GROUND FLOOR PLAN

04A - THE CHESTER



	BURREL HBECK	Aspect Architectural Design		
Title				Design
	TS 5,6,7 CHEST	Architectural Designer		
FLO	OR PLA VATION	NS &		29A Church Street Northborough Peterborough PE6 9BN Telephone 07907030047
Scale 1:100	Date MAR 21	Job No 243		© Copyright
Category	CiSfo Element	Sequential No 04	A	


1:100 at A3



FIRST FLOOR PLAN

House type 05A- THE WILLOUGHBY - 2 bed option Scale bar


GROUND FLOOR PLAN

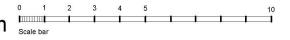

Title				Design
	TS 9,10, WILLOL		Architectural Designer	
FLO	OR PLAI VATIONS		29A Church Street Northborough Peterborough PE6 9BN Telephone 07907030047	
Scale 1:100	Date FEB 21	Job No 243		© Copyright
Category	CiSfb Element	Sequential No 05	Revisions	

Aspect Architectural



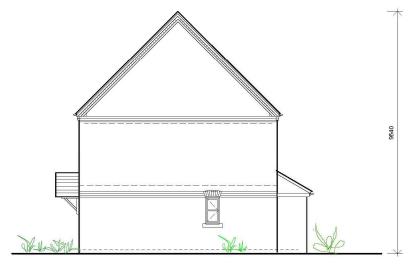

FRONT ELEVATION


REAR ELEVATION

GABLE ELEVATION



GROUND FLOOR PLAN FIRST FLOOR PLAN


House type 05B - THE WILLOUGHBY - 3 bed option

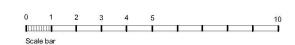


1:100 at A3

	BURREL HBECK	LS		Aspect Architectural Design
Title				Design
PLO THE	T 11 WILLOU	Architectural Designer		
	OR PLAI VATIONS	29A Church Street Northborough Peterborough PEG 9DN Telephone 07907030047		
Scale 1:100	Date FEB 21	Job No 243		© Copyright
Category	CiSfb Element	Sequential No 05B	Revisions	1

Rev B: Aug 22 - Floor plan altered to 3 bed 4 person

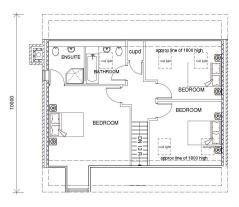


FIRST FLOOR PLAN

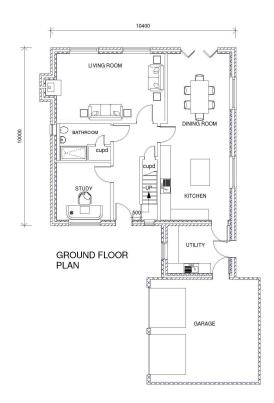






06A -The James

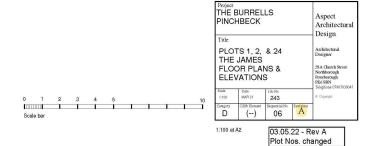

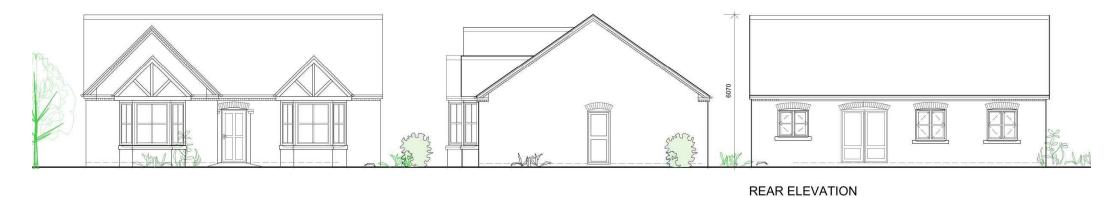

SIDE ELEVATION

11700 BEDROOM BEDROOM KITCHEN U DINING 7 BATHROOM SIDE ELEVATION

07A - THE EATON


GROUND FLOOR PLAN

BEDROOM

LIVING ROOM

ENSUITE

FRONT ELEVATION

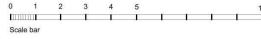

1:100 at A3

ategory

Project THE BURRELLS

PLAN & ELEVATION

MAR 21

PLOTS 13, 14,15, 20, & 23 Architectural Designer

Job No 243

07

A


PINCHBECK

Aspect

Architectural Design

29A Church Street Northborough Peterborough PE6 9BN Telephone 07907030047



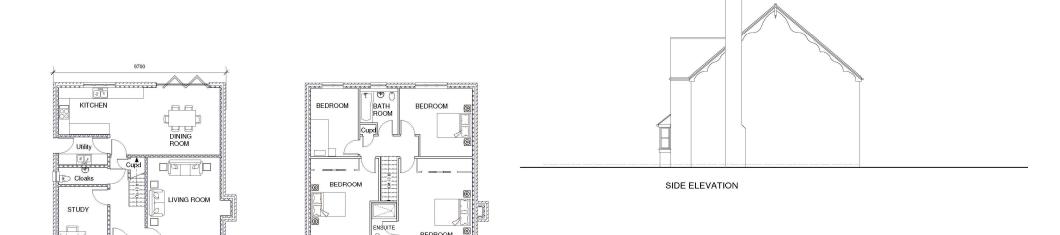

Project THE BURRELLS PINCHBECK


PLOTS 4, & 35
THE YORKE
FLOOR PLANS &
ELEVATIONS
1100 MM 31 243

Aspect Architectural Design


08A - The Yorke

FIRST FLOOR PLAN


GROUND FLOOR PLAN

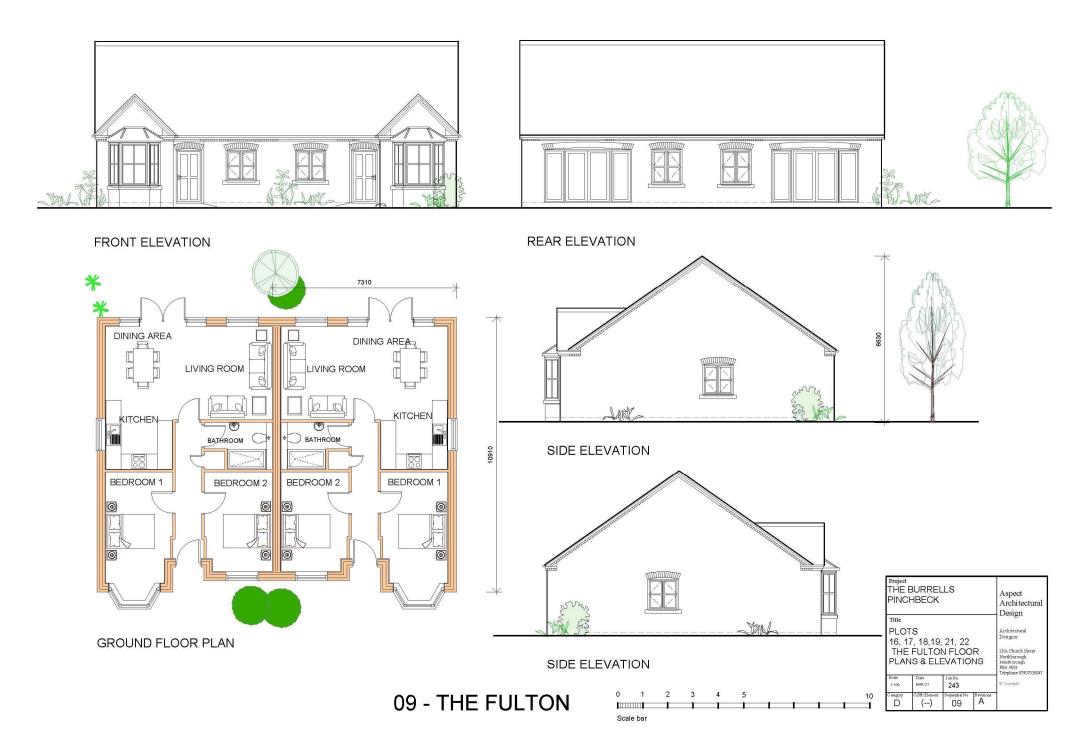



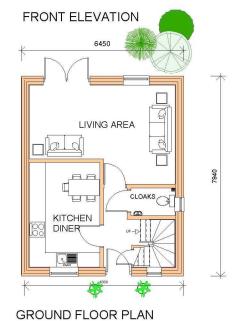


REAR ELEVATION

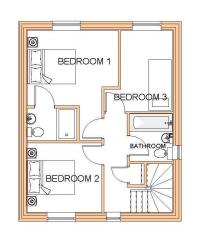

FIRST FLOOR PLAN

GABLE ELEVATION

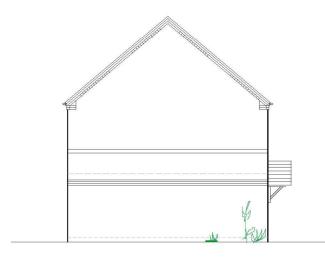


GABLE ELEVATION



equential No 10

1:100 at A3




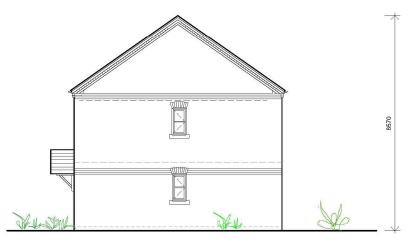


FRONT ELEVATION

REAR ELEVATION

GABLE ELEVATION

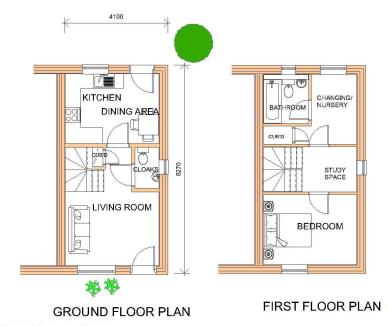

Total internal floor area: 56.6sqm

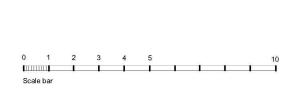

Project
THE BURRELLS
PINCHBECK

Title
PLOTS 29, 30
THE STANTON 1 bed option
FLOOR PLANS &
ELEVATIONS

Scale
1100
MM 21
104
1100
MM 21
105
1100
MM 21
1100

Rev A: Mar 22 - First floor plan altered to 1 bed

1:100 at A3

HOUSE TYPE 11A - THE STANTON 1 bed option








































































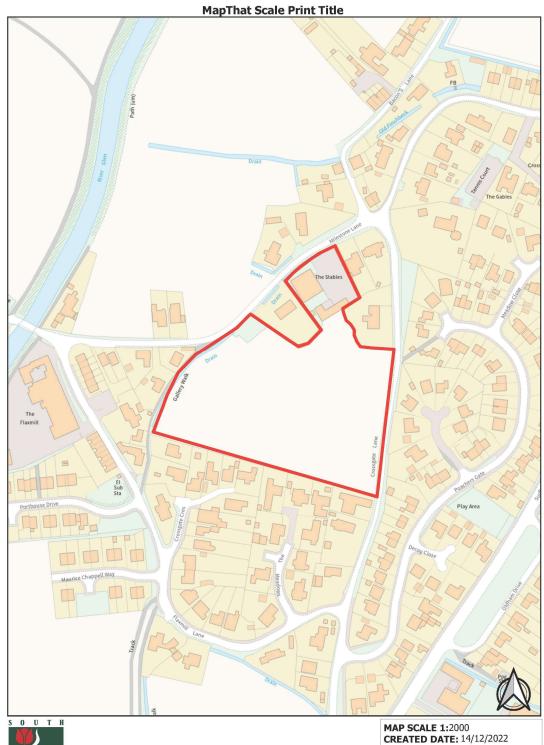




MAP SCALE 1:2000 CREATED DATE: 14/12/2022 PHOTOGRAPHIC COPY LIABLE TO DISTORTION IN SCALE







CREATED DATE: 15/12/2022 PHOTOGRAPHIC COPY LIABLE TO DISTORTION IN SCALE

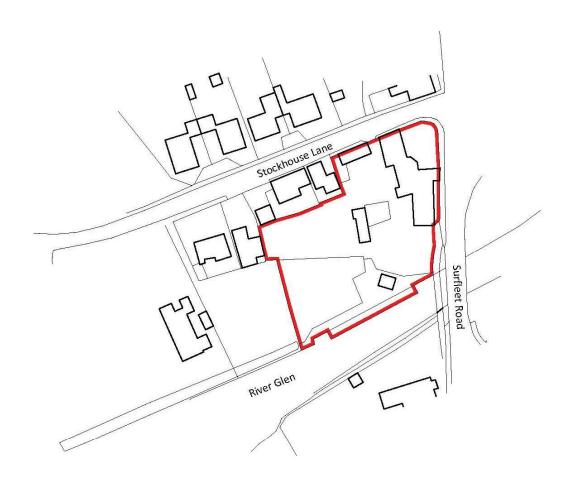

Notes

Copyright

© Robert Doughty Consultancy Limited.
All rights described in the Copyright, Designs and Patents Act 1988 have been asserted.

Ordnance Survey Map © Crown Copyright. OS Licence No: AR 100010613.

Description

Robert Doughty Consultancy

32 High Street, Helpringham Sleaford, Lincolnshire, NG34 0RA

Tel: 01529 421646

Email:admin@rdc-landplan.co.uk Web: www.rdc-landplan.co.uk

Client

Mr GJR & Mrs KF Swindells

Project

The Mermaid Inn

Surfleet

Drawing

Location Plan

Scale @ A4		Date 17/08/21	
1: 1250			
Drawn By		Checked By	
ww		LMS	
Job Number	Status	Purpose of Issue	
1447-1	PL	Planning	

Drawing No.


Rev


Date

1447-1_PL_LP01





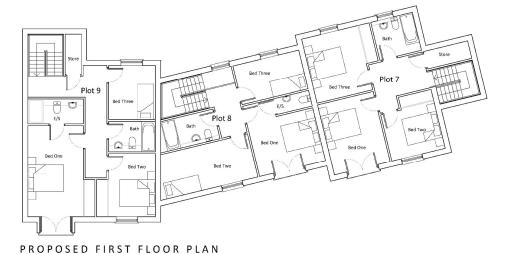

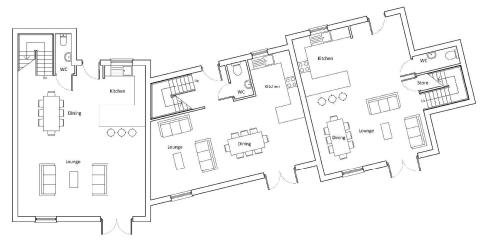

PROPOSED GROUND FLOOR PLAN

Copyright

© Robert Doughty Consultancy Limited.

All rights described in the Copyright, Designs and Patents Act 1988 have been asserted.

Ordnance Survey Map
© Crown Copyright. OS Licence No: AR 100010613.

Dimensions
All dimensions shown are for the purposes of obtaining the relevant planning permission only.

CDM 2015
This drawing is for illustrative purposes and/or obtaining the relevant planning permission only. It should not be used for construction and accordingly, risk identification under the Construction (Design & Management) Regulations 2015 has not been undertaken.



Α	Minor window position revisions	12.12.	
Rev	Description	Dat	



32 High Street, Helpringham Sleaford, Lincolnshire, NG34 ORA

Tel: 01529 421646 Email: admin@rdc-landplan.co.uk Web; www.rdc-landplan.co.uk

Client

Mr GJR & Mrs KF Swindells Project

The Mermaid Inn

Surfleet

Drawing

Proposed Townhouse Floor Plans Scale @ A2

1: 100 Drawn By PSS

26/09/22 Checked By PSS


Job Number Status Purpose of Issue 1447-1 Planning

Drawing No. 1447-1_PL_PL06


Α




PROPOSED SOUTH ELEVATION

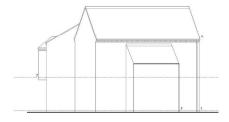

PROPOSED EAST ELEVATION

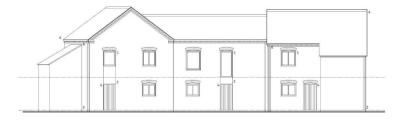

PROPOSED NORTH ELEVATION

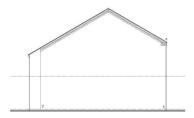

PROPOSED WEST ELEVATION

Material Schedule

- Reaf facing brickwork
 Vertical timber boarding
 Horizontal timber boarding
 Natural Slate roofing
 Hardwood Timber frame windows
 Hardwood Timber frame windows
 Hardwood Timber adors
 Lead to domner cheeks
 Black UPVC gutters and RWPs
 Tougherne glass Lulet Balcony


0 1 2 3 4 Sv A Window positions revised Brick detailing added Rev Description

Client Mr GJR & Mrs KF Swindells Project The Mermaid Inn Surfleet Drawing Proposed Townhouse Elevations


Date 26/09/22 Scale @ A1 1: 100 Drawn By PSS/ WW Checked By LMS Job Number Status Purpose of Issue 1447-1 PL Planning Drawing No. 1447-1_PL_EL04




- 1. Red facing brickwork
- 2. Natural Slate Roofing
- Aluminium PPC windows and doors
- 4. Black guttering and RWPs
- 5. Hardwood timber door

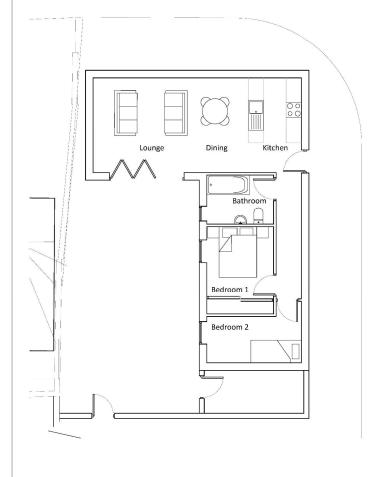



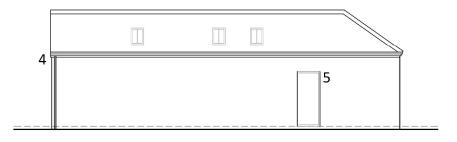

PROPOSED EAST ELEVATION

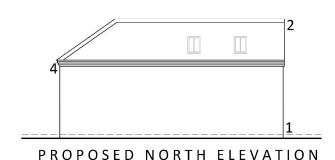



Notes

Copyright
© Robert Doughty Consultancy Limited.
All rights described in the Copyright, Designs and Patents Act 1988 have been asserted.

Ordnance Survey Map
© Crown Copyright. OS Licence No: AR 100010613.







32 High Street, Helpringham Sleaford, Lincolnshire, NG34 ORA

Tel:01529 421646 Email:admin@rdc-landplan.co.uk

Web: www.rdc-landplan.co.uk

Client

Mr GJR & Mrs KF Swindells

Project

The Mermaid Inn Surfleet

Drawing

Mews Dwelling (Plot 6)

	0,			
	Scale @ A3		Date	
	1: 100 Drawn By PSS		26/09/22 Checked By	
			-	
	Job Number	Status	Purpose of Issue	
	1447-1	PL	Planning	

Rev

Drawing No.

1447-1_PL_GA06



Red facing brickwork

Timber cladding



Timber cladding alongside red facing brickwork -



Slate roof


Dentil course detailing



Black UPVC rainwater goods -





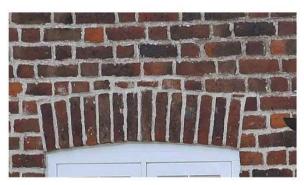



Red brick arch above windows and doors

White wooden casement windows




Client Mr GJR & Mrs KF Swindells Project
The Mermaid Inn, Surfleet

Drawing Example Images Job Number 1447-1 Drawing Number 1447-1_PL_PL08

Date -Drawn By -Checked By - 12/12/22 WW LMS

Tel: 01529 421646 Email: admin@rdc-landplan.co.uk Web: www.rdc-landplan.co.uk




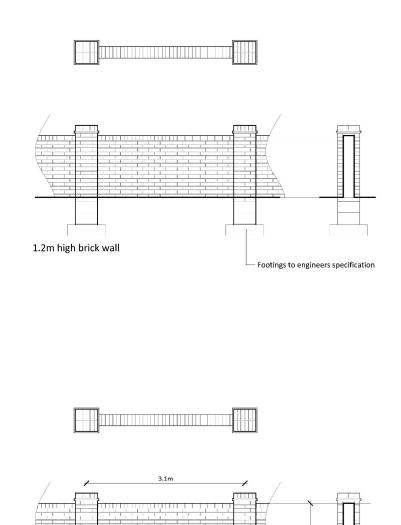


Brick to match house type

Footings to engineers specification


1.8m high brick wall

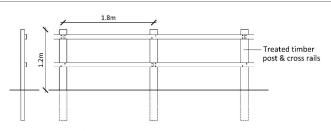


1.2m high post & rail fence

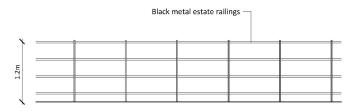

1.2m high metal railings

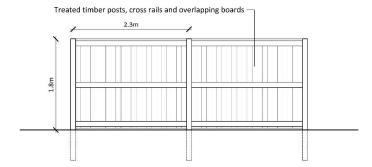

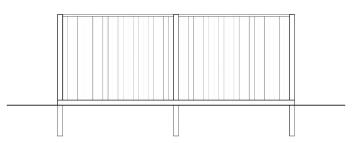

1.8m high close boarded fence


Notes

Copyright
© Robert Doughty Consultancy Limited.
All rights described in the Copyright, Designs and Patents Act 1988 have been asserted.

Ordnance Survey Map
© Crown Copyright. OS Licence No: AR 100010613.

CDM 2015

This drawing is for illustrative purposes and/or obtaining the relevant planning permission only. It should not be used for construction and accordingly, risk identification under the Construction (Design & Management) Regulations 2015 has not been undertaken.

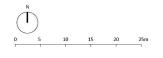

Rev	Description	Date



32 High Street, Helpringham Sleaford, Lincolnshire, NG34 ORA

Tel:01529 421646 Email:admin@rdc-landplan.co.uk Web: www.rdc-landplan.co.uk

Client

Mr GJR & Mrs KF Swindells

Project

The Mermaid Inn

Surfleet

Drawing

Boundary Treatments

Scale @ A3		Date	
1:50		16/08/21	
Drawn By		Checked By	
WW		LMS	
Job Number	Status	Purpose of Issue	
1447-1	PL	Planning	

Drawing No.

1447-1_PL_DD01

Rev



EXISTING EAST ELEVATION




EXISTING NORTH ELEVATION





EXISTING SOUTH ELEVATION

Client Mr GJR & Mrs KF Swindells Project The Merriaid Inn Surfleet Date 02/08/21 Checked By Drawing No. 1447-1_PL_EL01

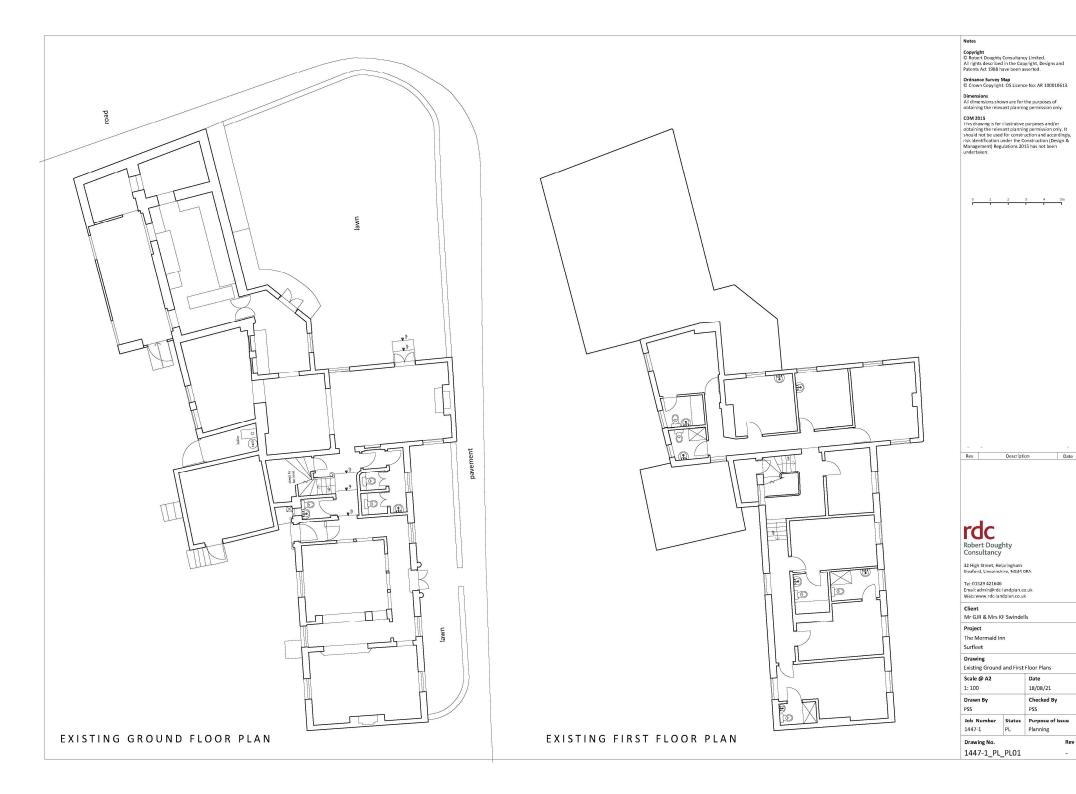



PROPOSED EAST ELEVATION



PROPOSED NORTH ELEVATION





PROPOSED SOUTH ELEVATION

Material Schedule

- Metration schedule:

 Historic arches retained and new brickwork infill with horizontal sliding sash timber windows installed within as the second of the sec

rdc Robert Doughty Consultancy

Client Mr GJR & Mrs KF Swindells

Project The Mermaid Inn

Surfleet

Date 26/09/22

1:100 Checked By PSS Drawn By Job Number Status Purpose of Issue 1447-1


1447-1_SK_EL03



Site Plan – Existing (noting names of various elements)



Key Phases of Construction / Analysis of building

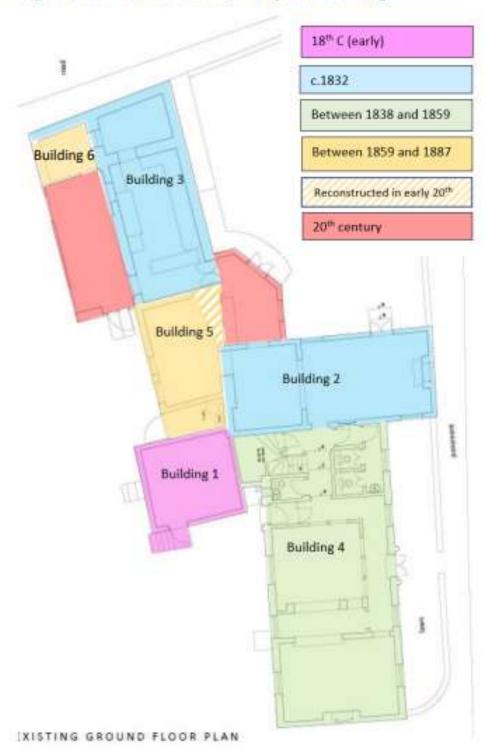

5. Existing Plan (including room names / numbers)







P2 - east elevation, note the parapet front to building 2



P3 - north elevations.



P4 – east elevation of stable. The modern requirements of a commercial kitchen detract from the exterior.



 ${\sf P5}$ – west elevations seen from beyond the garage.



P6 – west elevation, building 1 is the earliest surviving building on this site and once detached.





P7 - modern extension to stable block.

P8 - west elevation of building 5.



P9 - south elevation.



P10 - north elevation of Store- contains old brickwork at the lower level.



P11- south elevation of store - concrete block and a corrugated iron roof.



P12 – east elevation of garage



P13 – west elevation of garage and W.C.



P14 – looking from the public footpath from the River Glen. Old walls line the river, although much repaired and altered are the external wall of the brewery and other buildings that once existed.



P15 - the Mermaid Inn and the leaning tower of Surfleet parish church.



P16, the Mermaid Inn forms a pleasant 'stop' at the end of Station Road.



Fig 6, an undated photograph of an early 19th century house and attached cottages located on the frontage of the River Glen. These are the buildings seen clearly on Bryant's 1828 map as quite a large linear structure. This 1828 map identifies the plan of these buildings, and this photograph corroborates that the map is reasonably accurate. The house on the right may have been the dwelling house, noted on sales particulars in 1854, leaving the E-W range of what is now the Mermaid Inn more a separate public house, until it was extended in 1

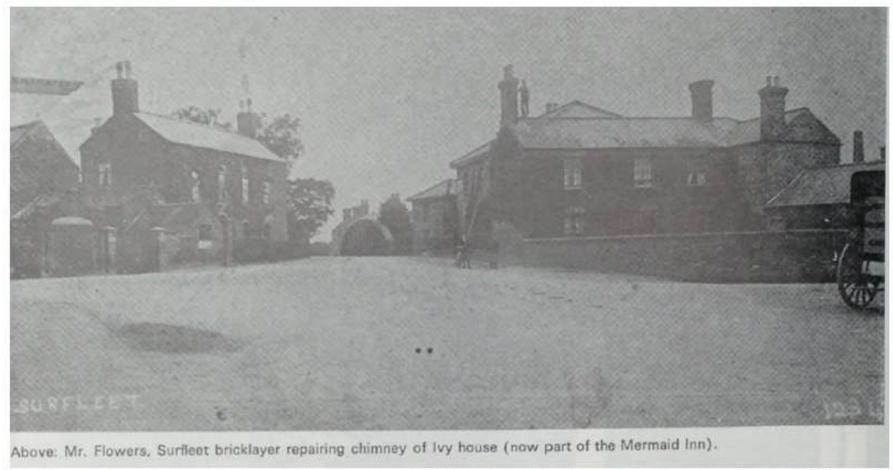


Fig 7, Photo — undated, but *circa* 1900 shows the 19th century range of The Mermaid. An article which features this photograph notes the building as 'Ivy House.' Trade directories and land tax records show that Alfred Ernest Smith lived here and that the building was used as a dwelling house, although a licence was retained for a public house, but not used between 1860 and 1939. Beyond Ivy House is the N-S range of the Mermaid Inn (what is now the principal architectural range). Beyond, is the side elevation of the early 19th C house seen in Fig 6. Note the different stacks on Ivy House, compared with its later extension on the right. What appears to be a projecting sign is seen on the end of the N-S range. This could well be advertising the brewery given the Mermaid Inn was not in use as a public house. The ridge stack on Ivy House indicates where the end of the building was until it was extended.



Fig 8, above, Mermaid Inn, 1964. Note the glazed panels to the front doors, and also a chimney stack on the rear roof slope (removed after 2009 – see google maps). The roof is slate. Note how the parapet of Building 2 is covered with the overhang of the hipped roof. This parapet indicates that the principal architectural front of Building 2 was its principal architectural or 'polite' elevation originally and that Building 4 was added to it later.

Fig 9, right, demonstrates the parapet is original with no alterations to the brickwork on the east elevation of Building 2 visible.

Source of image: Fig 8. Owner.

7. Photographs - Internal

Note: the Mermaid Inn contains little by way of internal features. Photographs are therefore confined to demonstrating elements of architectural merit.

Rooms which have been assigned as having no special interest have not been included in this document.



P15 – interior of Building 1. Contains a mid-19th century fireplace with cast insert, later tiled splays, and the remains of a grate. Two modern paving slabs form a hearth.

Timber clad ceiling late 19th C.




P16 – barrel vault to Building 1.



P17 – double elliptical arch to former stable.



P18 – altered, reduced, and plastered double elliptical arch to stable.

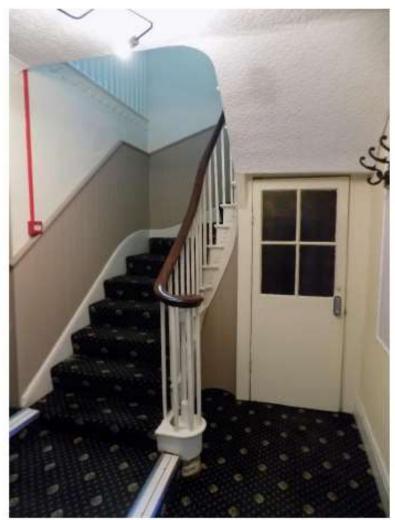

P19 – early 19th century stick baluster staircase. Note the unusual arrangement with a stone under the wreath(used to lift a re-used staircase to the level required?)



P20 - staircase detail - cut string, moulded tread ends.



P21 – above, first floor staircase hall. Arch to building 2. Note the floor level.

P22- right, a half landing four panel door on the stairs.





P23- steps to passage from the staircase hall to rooms FF1, FF2 and FF3.



P24 – below the stairs, note the central column and some reused timbers.



P25 – GF1, principal room of Building 4 contains an original cornice. Structural supports on walls to either side of the bar hold up what remains of the original chimney breast.





P28 – original door architrave and lining to front door.

 $\mbox{P29}-\mbox{ top right, arch topped Victorian door linings to the front door.}$









CREATED DATE: 15/12/2022 PHOTOGRAPHIC COPY LIABLE TO DISTORTION IN SCALE





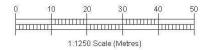

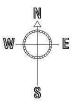



Ordnance Survey, (c) Crown Copyright 2022. All rights reserved. Licence number 100022432

Site Location Plan

Scale 1:1250 @ A4

This drawing may not be reproduced, made use of or issued to a third party without permission of; Gleeds Building Surveying Ltd. DO NOT SCALE - The contractor is responsible for checking all details and dimensions on site and using these in his tender submission and all subsequent work on site. THIS IS A CAD DRAWMIG - DO NOT ALTER

Denotes approximate applicant land ownership boundary

Denotes approximate areas of site works boundaries

Rev.	Description	Ву	Date

Client

East Lindsey District Council

Project

Listed Building Planning Application


Drawing Title

Site Location Plan 3 South Parade, Spalding Lincolnshire, PE11 2YJ

Drawing I	rawing No. BLBS0815-SLP		
Scale	1:1250	Original Sheet Size A	
		Drawing Status Planning	
gleeds		Drawn PJP	Checked OSP
J		Date Nov.2022	Rev.

Gleeds Building Surveying | T: +44 (0)117 3173200 | gleeds.com



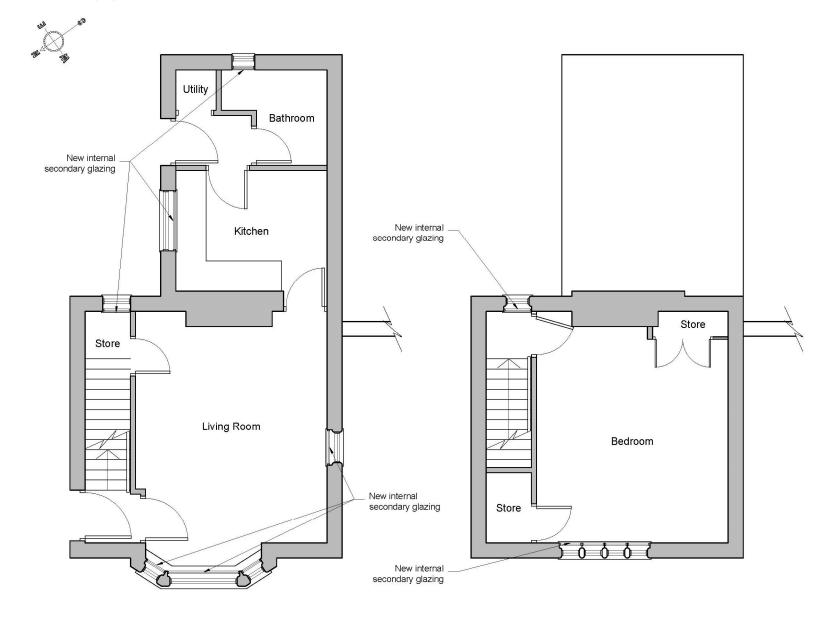

Proposed Ground Floor Plan Scale 1:50 @ A3

Proposed First Floor Plan Scale 1:50 @ A3

Rev.	Description	Ву	Date
Client			

East Lindsey District Council

Project


Listed Building Planning Application


Drawing Title

Proposed Floor Plans 3 South Parade Lincolnshire, PE11 2YJ

Drawing N	o BLBS	0815-PR-	-100
Scale	1:50	Origin	al Sheet Size A3
		Drawing Statu F	s Planning
gleeds		Drawn PJP	Checked OSP
		Date Nov.2022	Rev.



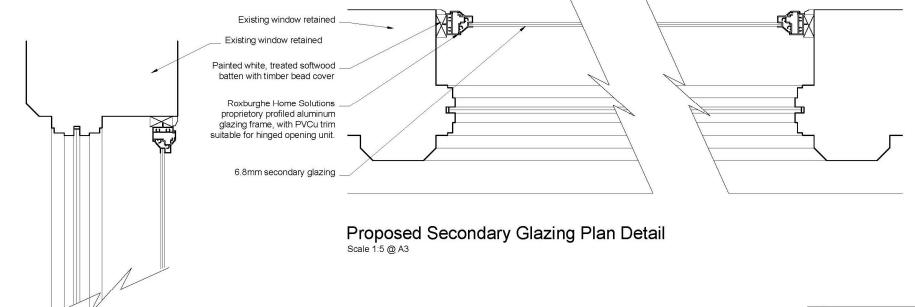

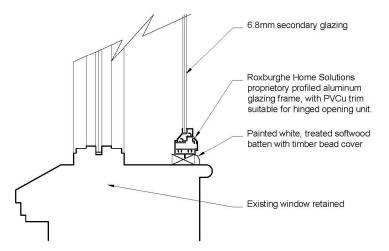

Proposed Secondary Glazing Section Detail

Scale 1:5 @ A3

Rev. Description By Date

Client

East Lindsey District Council

Project

Listed Building Planning Application

Drawing Title

Proposed Details 3 South Parade Lincolnshire, PE11 2YJ

Drawing No. BLBS0815-PR-D01		D01
Scale 1:5	Original Sheet Size A	
	Drawing Status Planning	
gleeds	Drawn PJP	Checked OSP
-	Date Nov.2022	Rev.















