





This drawing is the copyright of AXIS P.E.D Limited and may not be loaned, copied or reproduced in any way –or used for any offer, quote, bender or construction purposes without written consent of the company to do so • Date Application Boundary Photovoltaic Panels Deer / Stock Fence 2.1m Acoustic Fence 5m Solar Inverter / Transformer Station Solar Storage Building Solar Control Building Solar Switchgears Building Battery Storage Container Inverter / Transformer Station Control Building Switchgears Building Access Track Low Maintenance Pasture Species Rich Grassland Hedgerow Woodland Shelterbelt Existing ditch retained and enhanced - Existing public right of way Existing pylon Proposed ditch crossing BICKER FEN SOLAR FARM GENERAL ARRANGEMENT SHEET 3 2920-01*-*03c scale(s): 1:2500@A2

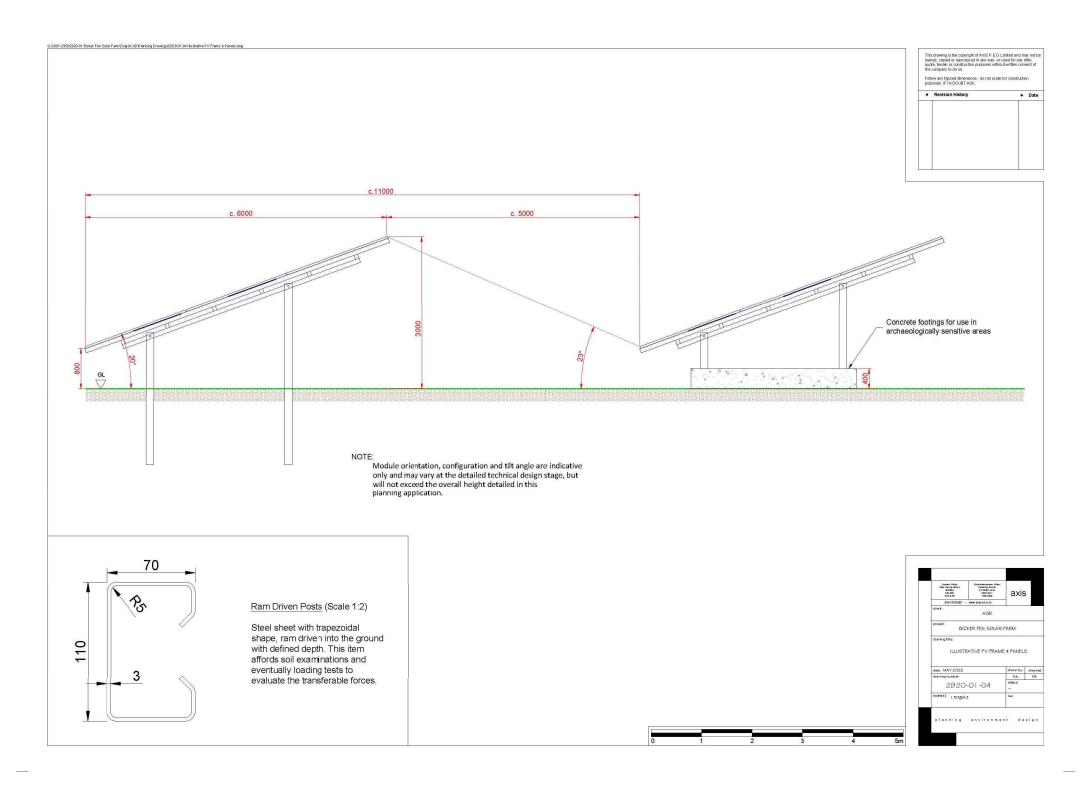

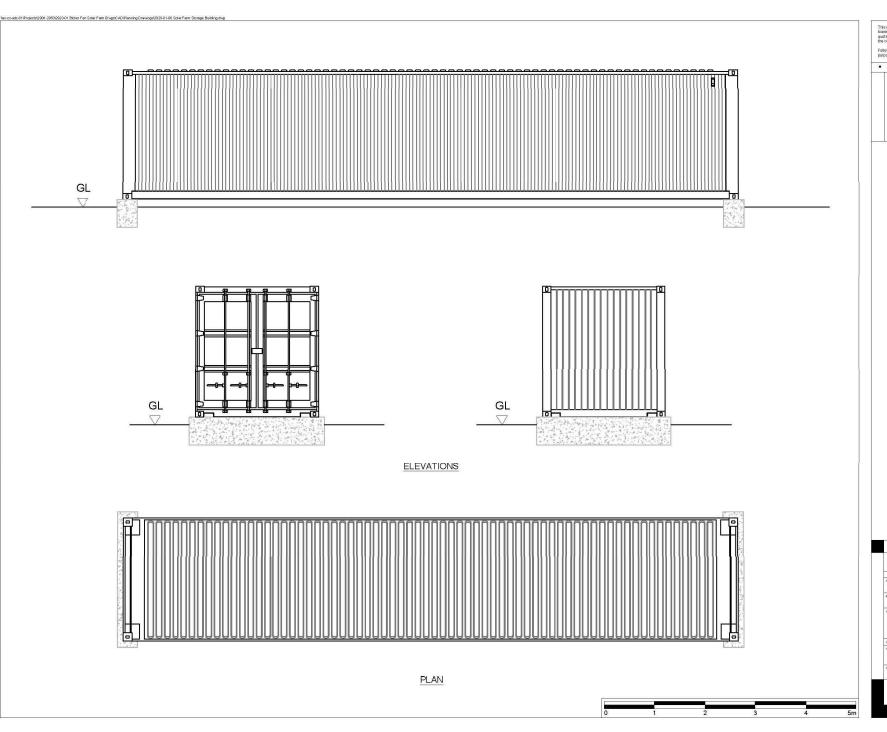


This drawing is the copyright of AXIS P.E.D. Limited and may not be loaned, copied or reproduced in any way- or used for any offer, quote, tender or construction purposes without written consent of the company to do so.

Follow any figured dimensions - do not scale for construction purposes. IF IN DOUBT ASK.

٠	Revision History	Date

Greater Giffee Vitel Sea de Sare C Stratte s Charater Cité S Dif	Southidenormier Office : Consetts 60000 72 Water Lone Wilm door 8X9 688	axis	5
100000000000000000000000000000000000000	www.aceped.co.st		
dient:	AGR		
project: BIC	KER FEN SOLAR	FARM	
drawing title:			
	SCLAR FARM STORAGE BUILD	ING	
date: MAY 2022		drawn by:	
date: MAY 2022 drawing number:		ING	checks PR
date: MAY 2022 drawing number:	STORAGE BUILD	drawn by:	

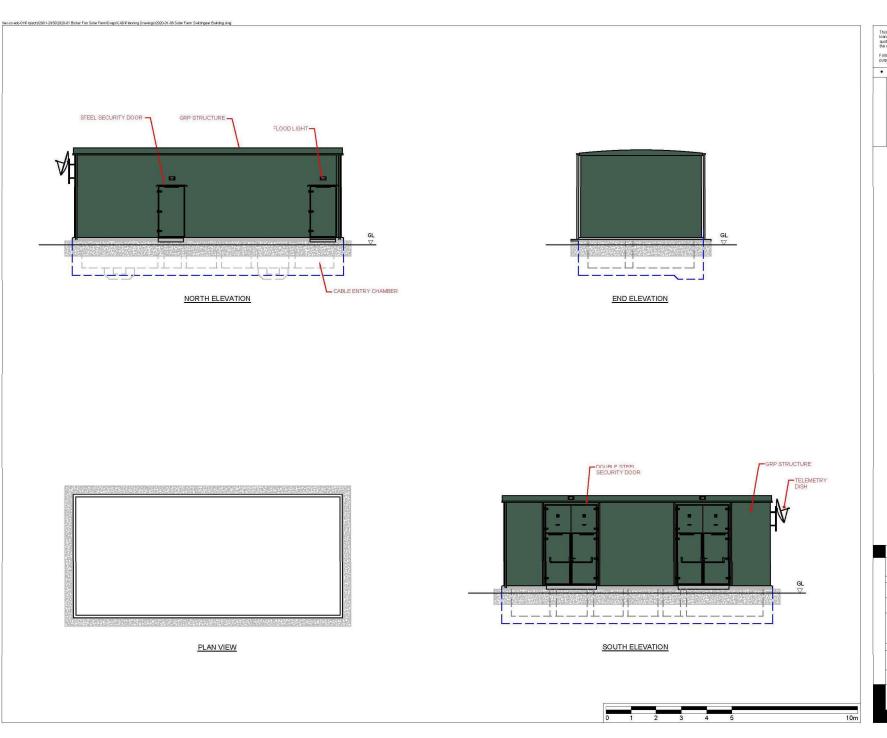


This drawing is the copyright of AXIS P.E. D. Limited and may not be loaned, copied or reproduced in any way, or used for any offer, quote, bender or construction purposes without written consent of the company to do so.

Follow any figured dimensions - do not scale for construction purposes. IF IN DOUBT ASK.

Revision History	Date





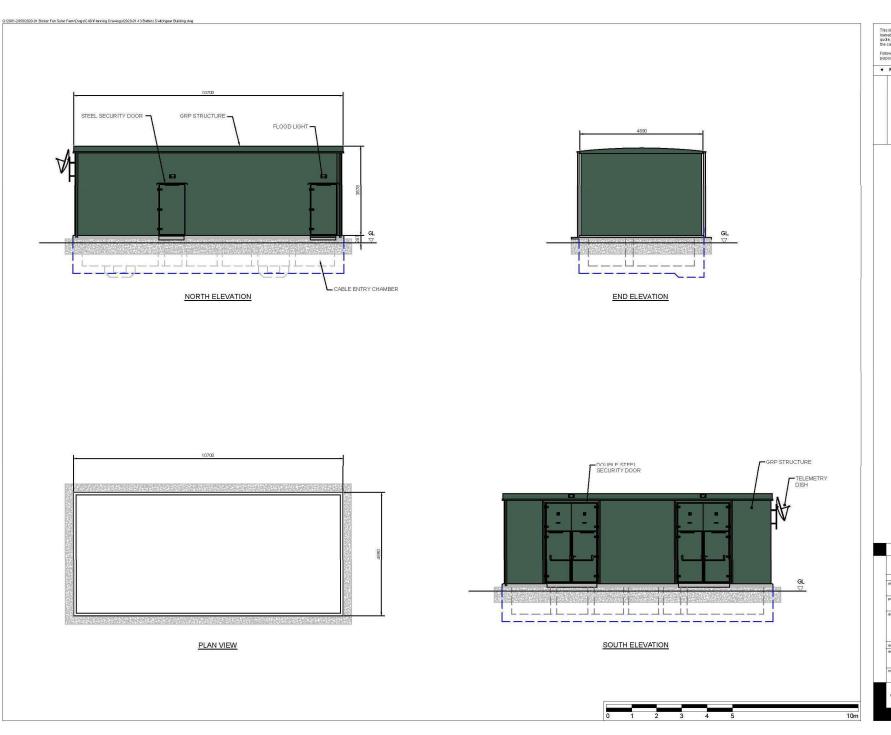


This drawing is the copyright of AXIS P.E.D. Limited and may not be loaned, copied or reproduced in any way-or used for any offer, quote, tender or construction purposes without written consent of the company to do so.

Follow any figured dimensions - do not scale for construction purposes. IF IN DO UBT ASK.

٠	Revision History	• Date



## **APPENDIX 1: HABITAT CREATION PLAN**

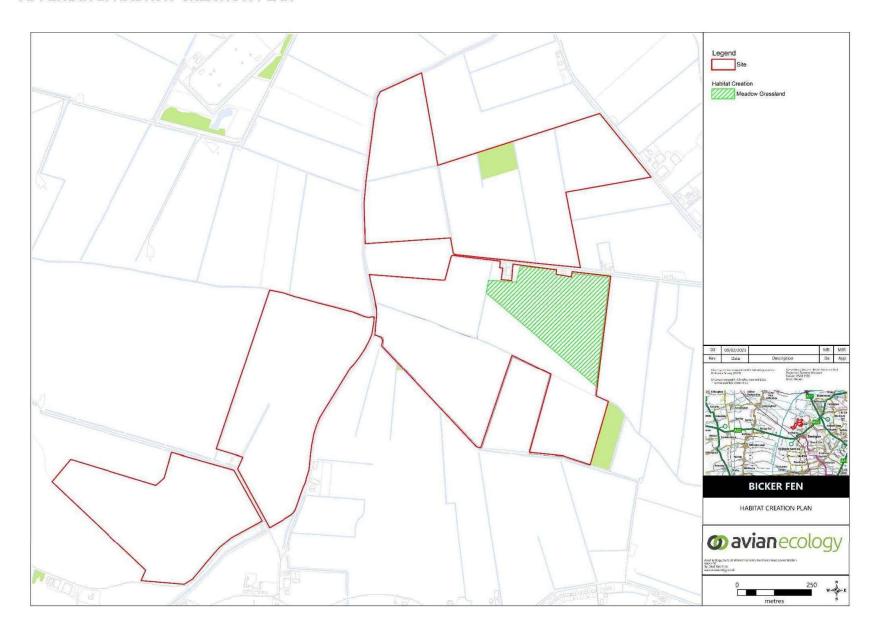








































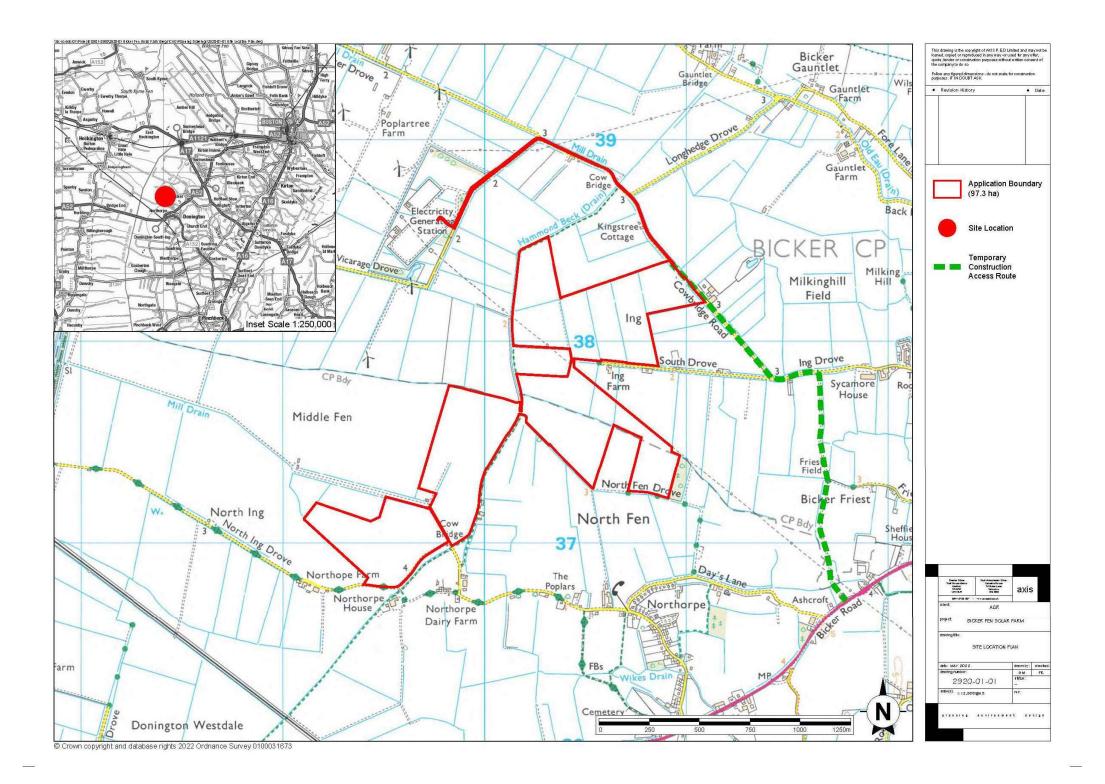








MAP SCALE 1:1250 CREATED DATE: 04/07/2023 PHOTOGRAPHIC COPY LIABLE TO DISTORTION IN SCALE



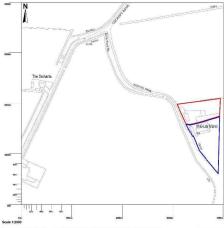

b Crown copyright and database rights 2022 OS 100054135. Map area bounded by: 530776,318714 331176,319114. Produced on 20 December 2022 from the OS National Geographic Database. Supplied by

LOCATION PLAN 1:2500



Architectural design and 3d Visualisatis
Linden House, Bracken Hill Road
East Lound, Nr Doncaster DN9 2LR
te 01427 753232
dannyg3dcadworx.com

	Project
	PROPOSED REPLACEMENT DWELLING
	OX CROFT BANK
٠	MOULTON CHAPEL
	PE12 OXT

Tite:
.OCATION PLAN
EXISTING AND PROPOSED SITE PLANS

1:00 @ A1 1:500 @ A1	11-2022	100000
T.DUI GAT	1174044	DS
Drawing No.	1024 - 1	01B



PROPOSED REAR ~ EAST ~ ELEVATION



PROPOSED SECTION A - A 1:100

PROPOSED SECTION B - B

1100 @ A1

11-2022 CWX1024 - 101A

ABCDEFGHJ

PROPOSED SIDE ~ SOUTH ELEVATION


Pictures from Design and Access Statement showing Office/Residential - proposed Garage









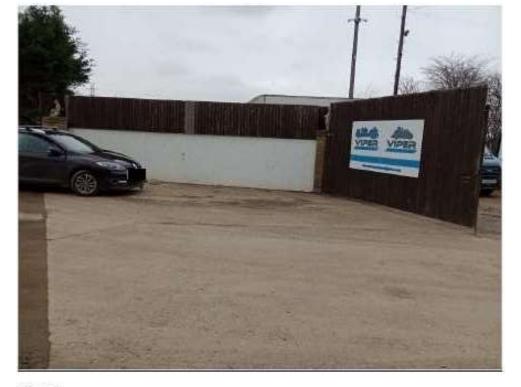

Site Entrance



Site entrance (other side)



View of site from entrance



Some existing vehicles on site



View looking at road outside of site



View of open storage, stable, container, rubbish on site. Tree screening on boundary visible also.



View looking toward site entrance. Other vehicles associated with haulage visible.



Haulage Vehicles on site.



More vehicles associated with lawful use, plus storage visible.



Further vehicles associated with haulage business.



Further view of vehicles.



View of bungalow on site.



Further view of bungalow.



Photo of rear of stable



Photo inside of stable



Further photo of Stable



Photo of flat bed trucks, trailer and open storage



Photo of Office/quasi residential to be turned back into a garage.





MAP SCALE 1:1250 CREATED DATE: 04/07/2023 PHOTOGRAPHIC COPY LIABLE TO DISTORTION IN SCALE








MAP SCALE 1:1250 CREATED DATE: 05/07/2023 PHOTOGRAPHIC COPY LIABLE TO DISTORTION IN SCALE

GENERAL NOTES: All dimensions to be checked on site. Use figured dimensions only. | All queries to be directed to the Architect. | Refer to Structural Engineer's drawings for all details relating to structure. | Any discrepancies between the Architect's drawings and those by any other party to be reported immediately. | All drawings are not for construction unless explicitly marked for this purpose.

GENERAL NOTES ON MATERIALS: Materials to comply with appropriate British Standards or Agreement Certificate stamped and independently certified or otherwise to show their suitability. | Materials should be in accordance with BS8000 series of documents and other accepted good practice (e.g. Quality assured to ISO9000),

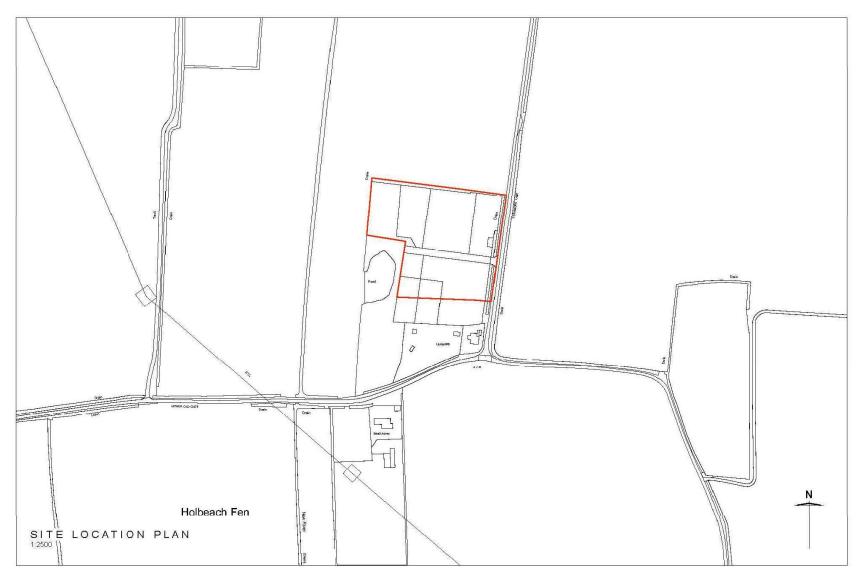






Project	PARAGRAPH 80 HOUSE	CRANMORE LANE, HOLBEACH	Drawing name SITE LOCATION PLAN	Drawing number 249 PL-100	Paper A3	Scale 1:2500	Date 01/23	Rev
					200			



GENERAL NOTES: All dimensions to be checked on site. | Use figured dimensions only. | All queries to be directed to the Architect. | Refer to Structural Engineer's drawings for all details relating to structure. | Any discrepancies between the Architect's drawings and those by any other party to be reported immediately. | All queries to be directed to the Architect. | Refer to Structural Engineer's drawings for all details relating to structure. | Any discrepancies between the Architect's drawings and those by any other party to be reported immediately. | All queries to be directed to the Architect. | Any discrepancies between the Architect's drawings and those by any other party to be reported immediately. | All queries to be directed to the Architect's drawings for all details relating to structure. | Any discrepancies between the Architect's drawings and those by any other party to be reported immediately. | All queries to be directed to the Architect's drawings for all details relating to structure. | Any discrepancies between the Architect's drawings and those by any other party to be reported immediately. | All queries to be directed to the Architect's drawings and those by any other party to be reported immediately. | All queries to be directed to the Architect's drawings and those by any other party to be reported immediately. | All queries to be directed to the Architect's drawings and those by any other party to be reported immediately. | All queries to be directed to the Architect's drawings and those by any other party to be reported immediately. | All queries to be directed to the Architect's drawings and those by any other party to be reported immediately. | All queries to be directed to the Architect's drawings and those by any other party to be reported immediately. | All queries to be directed to the Architect's drawings and those by any other party to be reported immediately. | All queries to be directed to the Architect's drawings and those by any other party to be reported immediately and th

GENERAL NOTES ON MATERIALS: Materials to comply with appropriate British Standards or Agrément Certificate stamped and independently certified or otherwise to show their suitability. | Materials should be in accordance with BS8000 series of documents and other accepted good practice (e.g. Quality assured to ISO9000).

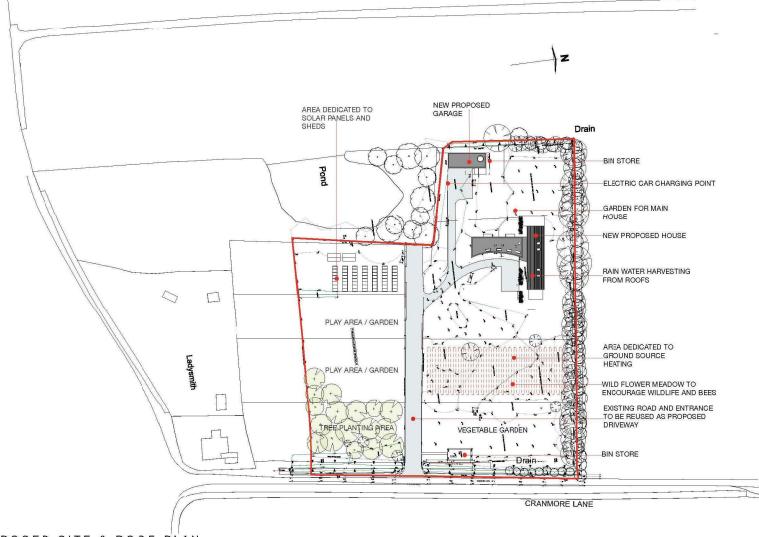

PROPOSED SITE & ROOF PLAN

REV A: 05-06-23 - AMENDMENTS TO PROPOSED PLAN TO INCORPORATE ADDITIONAL BIN STORE, TREE PLANTING BASED ON PLANNER FEEDBACK REV B: 13-06-23 - AMENDMENTS TO BUILDING POSITION REV C: 14-06-23 - AMENDMENTS TO BUILDING POSITION

Do not scale from this drawing. Figured dimensions are taken to structure unless indicated otherwise. All dimensions to be checked on site prior to commencement of work. Drawing to be read in conjunction with all other Architect's drawings, Consultant's and Specialist's drawings, construction notes and specifications.

Paper Scale Date Rev PARAGRAPH 80 HOUSE PROPOSED SITE AND ROOF PLAN CRANMORE LANE, HOLBEACH 249 PL-103









GENERAL NOTES: <u>All dimensions to be checked on site.</u> Use figured dimensions only. | All queries to be directed to the Architect. | Refer to Structural Engineer's drawings for all details relating to structure. | Any discrepancies between the Architect's drawings and those by any other party to be reported immediately. | <u>All drawings are not for construction unless explicitly marked for this purpose.</u>

GENERAL NOTES ON MATERIALS: Materials to comply with appropriate British Standards or Agrément Certificate stamped and independently certified or otherwise to show their suitability. | Materials should be in accordance with BS8000 series of documents and other accepted good practice (e.g., Quality assured to ISC8000).











GENERAL NOTES: All dimensions to be checked on site. Use figured dimensions only, | All queries to be directed to the Architect. | Refer to Structural Engineer's drawings for all details relating to structure. | Any discrepancies between the Architect's drawings and those by any other party to be reported immediately. | All drawings are not for construction unless explicitly marked for this purpose.

GENERAL NOTES ON MATERIALS: Materials to comply with appropriate British Standards or Agreement Certificate stamped and independently certified or otherwise to show their suitability. | Materials should be in accordance with BS8000 series of documents and other accepted good practice (e.g. Quality assured to ISO9000).

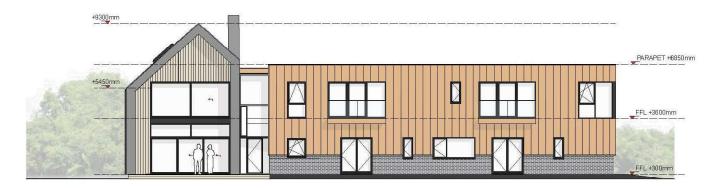

## PROPOSED NORTH ELEVATION

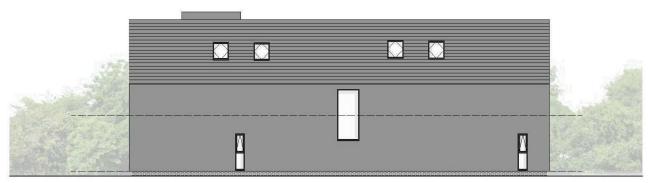

PROPOSED EAST ELEVATION

Do not scale from this drawing. Figured dimensions are taken to structure unless indicated otherwise. All dimensions to be checked on site prior to commencement of work. Drawing to be read in conjunction with all other Architect's drawings, Consultant's and Specialist's drawings, construction notes and specifications.



25 27	V00 - 1200		700	Artist and the second s
PARAGRAPH 80 HOUSE	CRANMORE LANE, HOLBEACH	PROPOSED ELEVATIONS P1	Drawing number 249 PL-106	A3 1:150 01/23



GENERAL NOTES: All dimensions to be checked on site. | Use figured dimensions only. | All queries to be directed to the Architect. | Refer to Structural Engineer's drawings for all details relating to structure. | Any discrepancies between the Architect's drawings and those by any other party to be reported immediately. | All drawings are not for construction unless explicitly marked for this purpose.

GENERAL NOTES ON MATERIALS: Materials to comply with appropriate British Standards or Agrément Certificate stamped and independently certified or otherwise to show their suitability, | Materials should be in accordance with BS8000 series of documents and other accepted good practice (e.g. Quality assured to ISO9000),



PROPOSED SOUTH ELEVATION



PROPOSED WEST ELEVATION

Do not scale from this drawing. Figured dimensions are taken to structure unless indicated otherwise. All dimensions to be checked on site prior to commencement of work. Drawing to be read in conjunction with all other Architect's drawings, Consultart's and Specialist's drawings, construction notes and specifications.



PARAGRAPH 80 HOUSE CRANMORE LANE, HOLBEACH	PROPOSED ELEVATIONS P2	Drawing number 249 PL-107	Paper   Scale   Date   Rev
--	------------------------	---------------------------	----------------------------



GENERAL NOTEs: All dimensions to be checked on site. Use figured dimensions only. | All queries to be directed to the Architect. | Refer to Structural Engineer's drawings for all details relating to structure. | Any discrepancies between the Architect's drawings and those by any other party to be reported immediately. | All drawings are not for construction unless explicitly marked for this purpose.

GENERAL NOTES ON MATERIALS: Materials to comply with appropriate British Standards or Agrément Certificate stamped and independently certified or otherwise to show their suitability. | Materials should be in accordance with BS8000 series of documents and other accepted good practice (e.g., Quality assured to ISC9000).









GENERAL NOTES: All dimensions to be checked on site.) Use figured dimensions only, | All queries to be directed to the Architect | Refer to Structural Engineer's drawings for all details relating to structure. | Any discrepancies between the Architect's drawings and those by any other party to be reported immediately, | All drawings are not for construction unless explicitly marked for this purpose.

GENERAL NOTES ON MATERIALS: Materials to comply with appropriate British Standards or Agrément Certificate stamped and independently certified or otherwise to show their suitability. | Materials should be in accordance with BS8000 series of documents and other accepted good practice (e.g. Quality assured to ISC9000),



PROPOSED FIRST FLOOR PLAN 1:150

Do not scale from this drawing. Figured dimensions are taken to structure unless indicated otherwise. All dimensions to be checked on site prior to commencement of work. Drawing to be read in conjunction with all other Architect's drawings, Consultant's and Specialist's drawings, construction notes and specifications.



23. ENSUITE

30 BEDROOM 2

32. ENSUITE





GENERAL NOTES: All dimensions to be checked on site. | Use figured dimensions only. | All queries to be directed to the Architect. | Refer to Structural Engineer's drawings for all details relating to structure. | Any discrepancies between the Architect's drawings and those by any other party to be reported immediately. | All dawings are not for construction unless explicitly marked for this purpose.

GENERAL NOTES ON MATERIALS: Materials to comply with appropriate British Standards or Agrément Certificate stamped and independently certified or otherwise to show their suitability. | Materials should be in accordance with BS8000 series of documents and other accepted good practice (e.g. Quality assured to ISO9000).



# 



 $\underset{1:100}{\mathsf{PROPOSED}}\ \mathsf{EAST}\ \mathsf{ELEVATION}$ 


Do not scale from this drawing. Figured dimensions are taken to structure unless indicated otherwise. All dimensions to be checked on site prior to commencement of work. Drawing to be read in conjunction with all other Architect's drawings, Consultant's and Specialist's drawings, construction notes and specifications.




Project	PARAGRAPH 80 HOUSE	CRANMORE LANE, HOLBEACH	PROPOSED GARAGE ELEVATIONS P1	Drawing number 249 PL-112	Paper A3	1:100	Date 01/23	Rev	
					•				

GENERAL NOTES: All dimensions to be checked on site. | Use figured dimensions only, | All queries to be directed to the Architect. | Refer to Structural Engineer's drawings for all details relating to structure. | Any discrepancies between the Architect's drawings and those by any other party to be reported immediately. | All drawings are not for construction unless explicitly marked for this purpose.

GENERAL NOTES ON MATERIALS: Materials to comply with appropriate British Standards or Agrément Certificate stamped and independently certified or otherwise to show their suitability. | Materials should be in accordance with BS8000 series of documents and other accepted good practice (e.g. Quality assured to ISO9000).

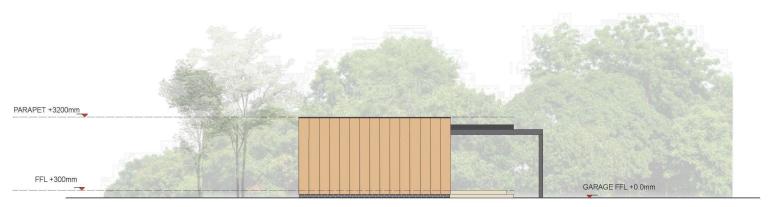

PROPOSED SOUTH ELEVATION

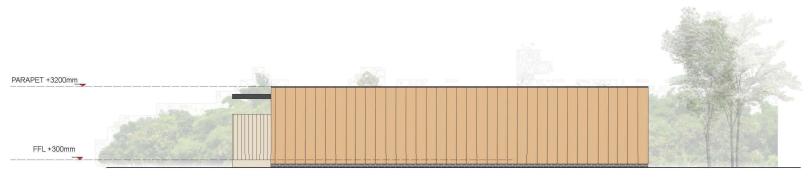

PROPOSED WEST ELEVATION

Do not scale from this drawing. Figured dimensions are taken to strucure unless indicated otherwise. All dimensions to be checked on site prior to commencement of work. Drawing to be read in conjunction with all other Architect's drawings, Consultant's and Specialist's drawings, construction notes and specifications.



			0000 - 12 - 12 - 12 - 12 - 12 - 12 - 12	
Project PARAGRAPH 80 HOUSE	CRANMORE LANE, HOLBEACH	PROPOSED GARAGE ELEVATIONS P2	Drawing number 249 PL-113	Paper Scale Date Rev A3 1:100 01/23




GENERAL NOTES: All dimensions to be checked on site. Use figured dimensions only. All queries to be directed to the Architect. Refer to Structural Engineer's drawings for all details relating to structure. Any discrepancies between the Architect's drawings and those by any other party to be reported immediately. All drawings are not for construction unless explicitly marked for this purpose.

GENERAL NOTES ON MATERIALS: Materials to comply with appropriate British Standards or Agrément Certificate stamped and independently certified or otherwise to show their suitability. | Materials should be in accordance with BS8000 series of documents and other accepted good practice (e.g., Quality assured to ISO8000),



Do not scale from this drawing. Figured dimensions are taken to structure unless indicated otherwise. All dimensions to be checked on site prior to commencement of work. Drawing to be read in conjunction with all other Architect's drawings, Consultant's and Specialist's drawings, construction notes and specifications.



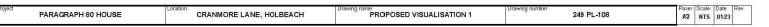




GENERAL NOTES: All dimensions to be checked on site. Use figured dimensions only. | All queries to be directed to the Architect. | Refer to Structural Engineer's drawings for all details relating to structure. | Any discrepancies between the Architect's drawings and those by any other party to be reported immediately. | All drawings are not for construction unless explicitly marked for this purpose.

GENERAL NOTES ON MATERIALS: Materials to comply with appropriate British Standards or Agrément Certificate stamped and independently certified or otherwise to show their suitability. | Materials should be in accordance with BS8000 series of documents and other accepted good practice (e.g., Quality assured to ISO9000).







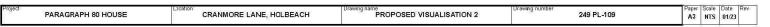



GENERAL NOTES: All dimensions to be checked on site. Use figured dimensions only. All queries to be directed to the Architect, Refer to Structural Engineer's drawings for all details relating to structure. Any discrepancies between the Architect's drawings and those by any other party to be reported immediately. All drawings are not for construction unless explicitly marked for this purpose.

GENERAL NOTES ON MATERIALS: Materials to comply with appropriate British Standards or Agrément Certificate stamped and independently certified or otherwise to show their suitability. | Materials should be in accordance with BS8000 series of documents and other accepted good practice (e.g., Quality assured to ISO9000).



















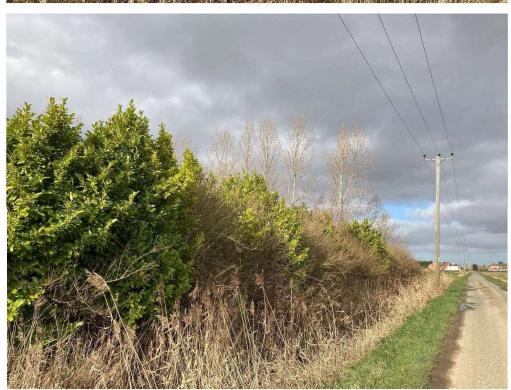





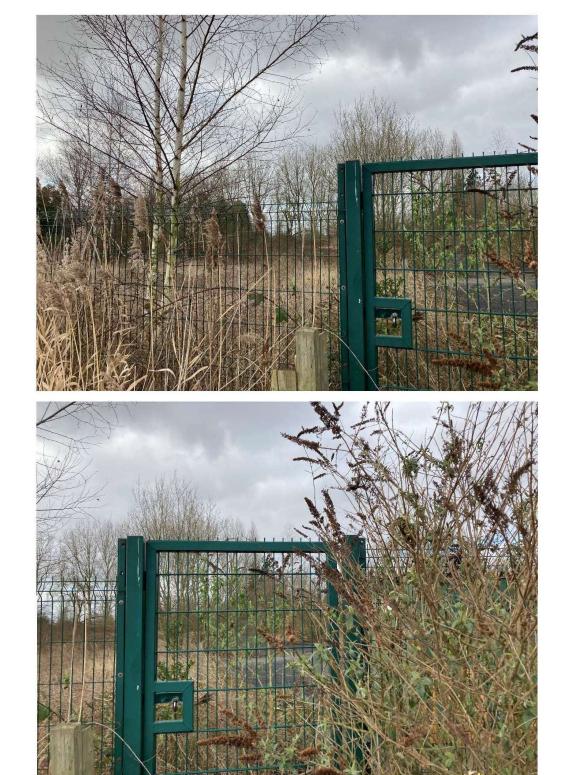











MAP SCALE 1:1250 CREATED DATE: 05/07/2023 PHOTOGRAPHIC COPY LIABLE TO DISTORTION IN SCALE

